

Office Dwg.No.	Arch. Dwg.No.	Name of Building	Title of Drawing	BRANCH	Date	Prepared By
CPA-726	E-1		Lower Level			
CPA-727	E-2		Concourse Level			
CPA-728	E-3		Truss Level-Wiring			
CPA-729	E-4		Riser Diagram & Details			
CPA-730	E-5		Schedules & Diagrams			
CPA-731		ROOF REPLACEMENT ENG.NO.-M-219-35	CAPITAL PLAZA FRANKFORT, KY.		12-91	ROSS-FELDMAN-AR
CRA-732	D-1	DEMOL.PLAN & DETAILS				
CPA-733	A-1	ROOF PLAN				
CPA-734	A-2	ROOF PLAN				
CPA-735	A-3	DETAILS				
CPA-736		CAPITAL PLAZA ROOF REPLACEMENT PHASE#2	FRANKFORT, KY.		5-92	ROSS-FELDMAN
CPA-737	D-1	DEMO. ENG.NO.M-219-35				
Cpa-738	A-1	PARTIAL ROOF				
CPA-739	A-2	-----ROOF				
CPA-740	A-3	-----ROOF				
CPA-741	A-4	DETAILS				
CPA-742	A-5	DETAIL:S				
CPA-743		ROOF REPLACEMENT CAPITAL PLAZA TOWER FRANKFORT, KY. ENG. FILE NO. M-210-44			2/95	WILLIAM MARTIN
CPA-744	A-1	PROJECT ACCESS PLANS				
CPA-745	A-2	ROOF PLANS				
CPA-746	A-3	DETAILS				
CPA-747	<i>ASB UNIT 7/15/97</i>	CAPITAL PLAZA ROOF REPLACEMENT			4/96	ROSS/TARRANT AR
CPA-748	AD-1	PHASE II M-219-43	Architectural Demolition Plan			
CPA-749	HM-1		Hazardous Materials Abatement			
CPA-750	HM-2		Hazardous Materials Abatement			
CPA-751	HM-3		Hazardous Materials Abatement			
CPA-752	HM-4		Hazardous Materials Abatement			
CPA-753						

CAPITAL PLAZA ROOF REPLACEMENT

PHASE 2

COMMONWEALTH OF KENTUCKY FRANKFORT, KENTUCKY

GOVERNOR BRERETON JONES

FINANCE & ADMINISTRATION CABINET
DEPARTMENT FOR FACILITIES MANAGEMENT
DIVISION OF ENGINEERING
ENGINEERING FILE NO. M- 219-35-B
ACCOUNT NO.

NOTE:

Roof Replacement Project will be conducted simultaneously with work under Owner's separate Asbestos Abatement Contract. Roof Replacement Project Bidders are advised to review and become familiar with the Project documents for the Asbestos Abatement Contract, prepared by David C. Banks, AIA, Architect of Frankfort, Kentucky, dated November, 1991.

Asbestos Abatement: Ross-Feldman Architecture, Inc. is in no way associated with identification or abatement of hazardous materials. Ross-Feldman Architecture, Inc. will not warrant that any or all hazardous materials have or will be identified or abated. Said warranty is the sole responsibility of the Owner's separate Asbestos Abatement Contract. Information regarding the separate contract for Asbestos Abatement has been provided by the Owner from documents prepared by David C. Banks, AIA, Architect, and dated November 1991.


INDEX OF DRAWINGS

COVER SHEET


D-1 DEMOLITION PLAN AND DETAILS
A-1 PARTIAL ROOF PLAN
A-2 PARTIAL ROOF PLAN
A-3 PARTIAL ROOF PLAN
A-4 DETAILS
A-5 DETAILS

ROSS • FELDMAN ARCHITECTURE, INC.

206 West Main Street Lexington, Kentucky 40507 (606)254-4018

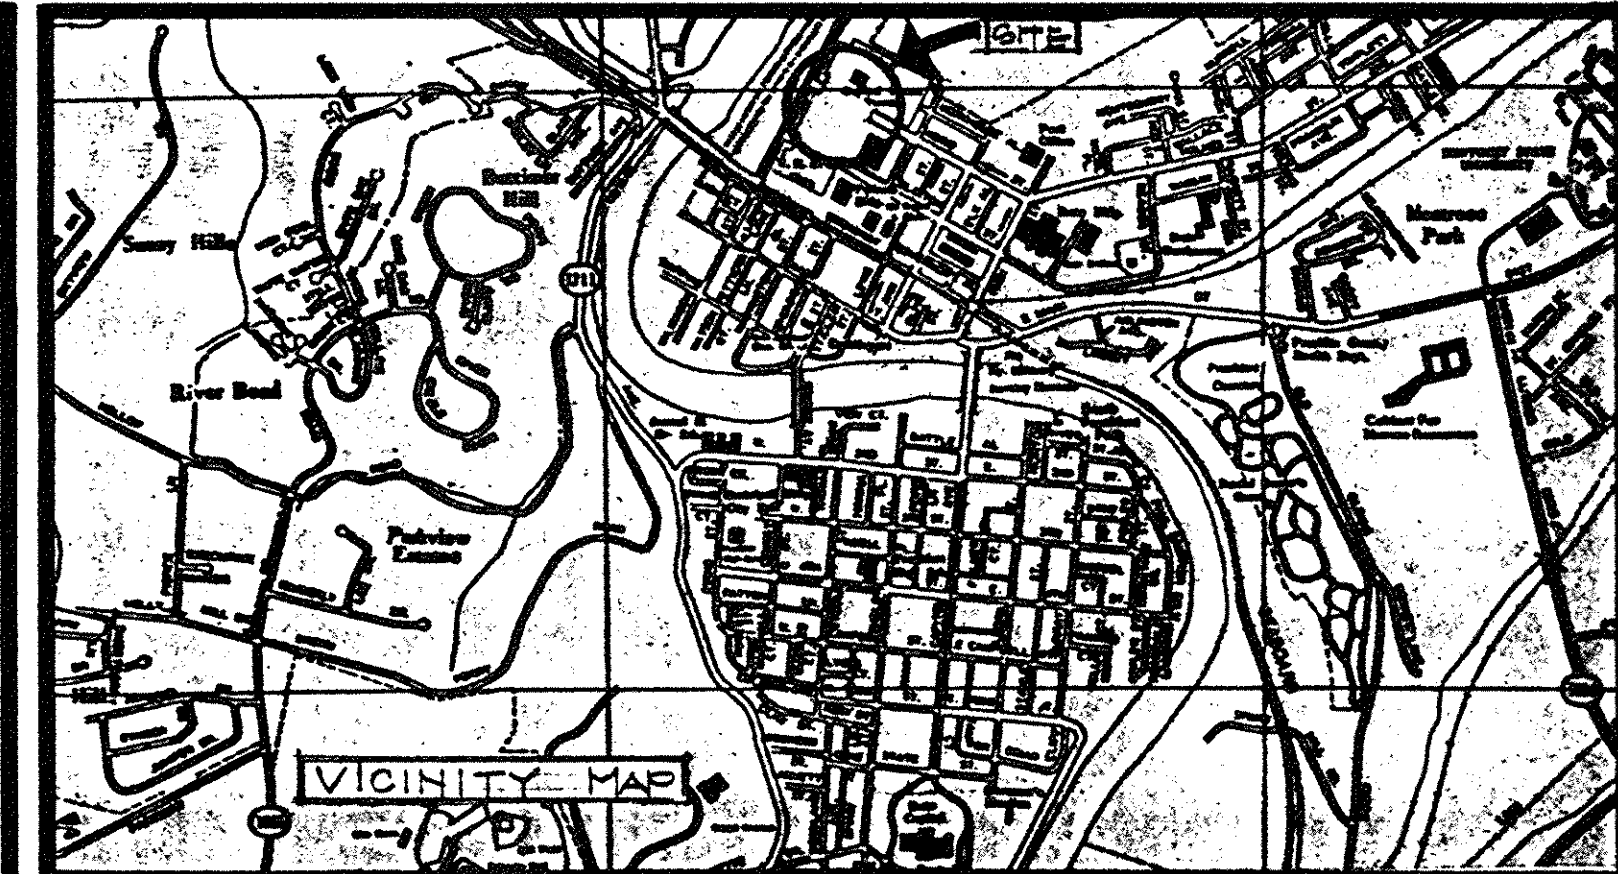

SET NUMBER _____

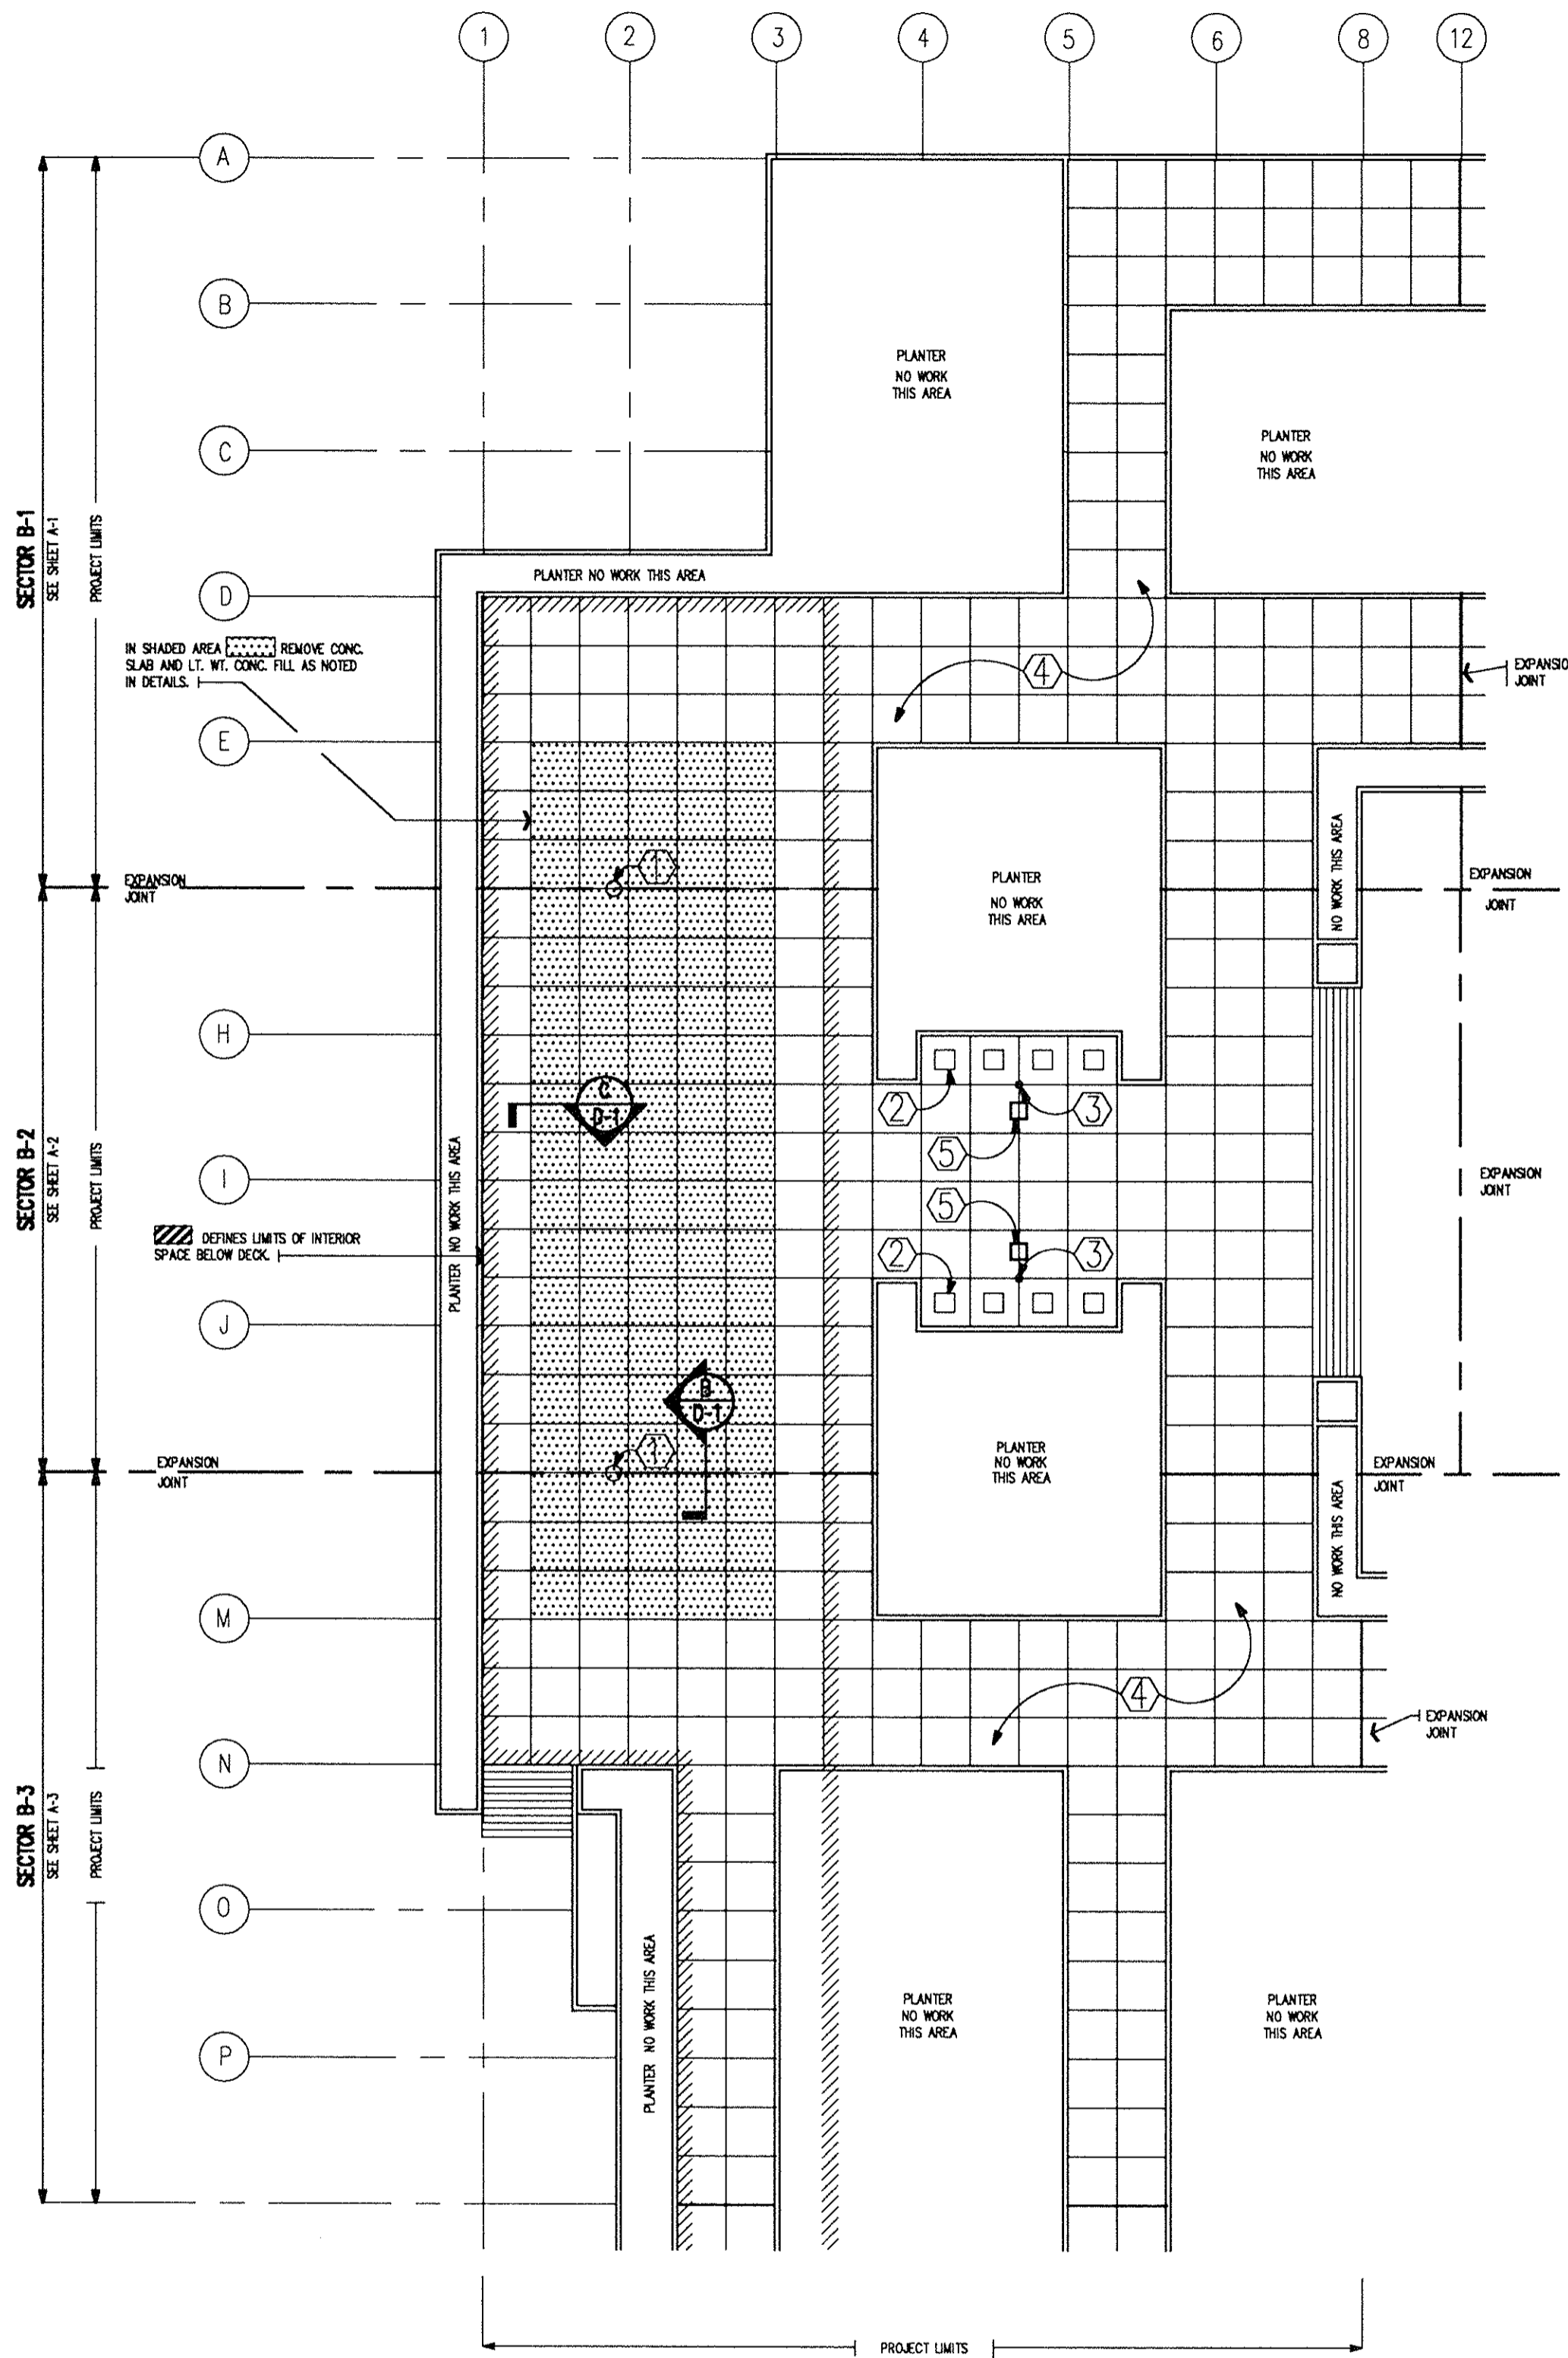


A
DEMOLITION PLAN
1" = 30' - 0"

NOTES


- ① EXISTING LIGHT FIXTURE/VENT STACK - REMOVE PER DETAIL D/D-1. SEE PLAN A/A-2 FOR RELOCATION.
- ② EXISTING PRECAST CONCRETE BENCHES TO BE REMOVED AND REPLACED AS REQUIRED BY WORK IN THIS AREA.
- ③ EXISTING FLAGPOLES TO REMAIN.
- ④ EXISTING 10'x10' (TYP.) PRECAST CONCRETE PAVERS TO BE REMOVED AND SALVAGED FOR REINSTALLATION - SEE DETAIL D/A-4 AND SPECS. FOR INSERTS TO BE USED IN LIFTING PANELS.
- ⑤ EXISTING LIGHT FIXTURES TO REMAIN.

NOTE : G.C. SHALL PROVIDE ENCLOSURE FENCE/BARRICADE @ PROJECT LIMIT FOR SAFETY AND SECURITY AS REQ'D. THRU END OF CONSTRUCTION. OWNER'S ASBESTOS ABATEMENT CONTRACTOR SHALL PROVIDE ADDITIONAL ENCLOSURES AS REQ'D. BY WORK UNDER THAT CONTRACT.

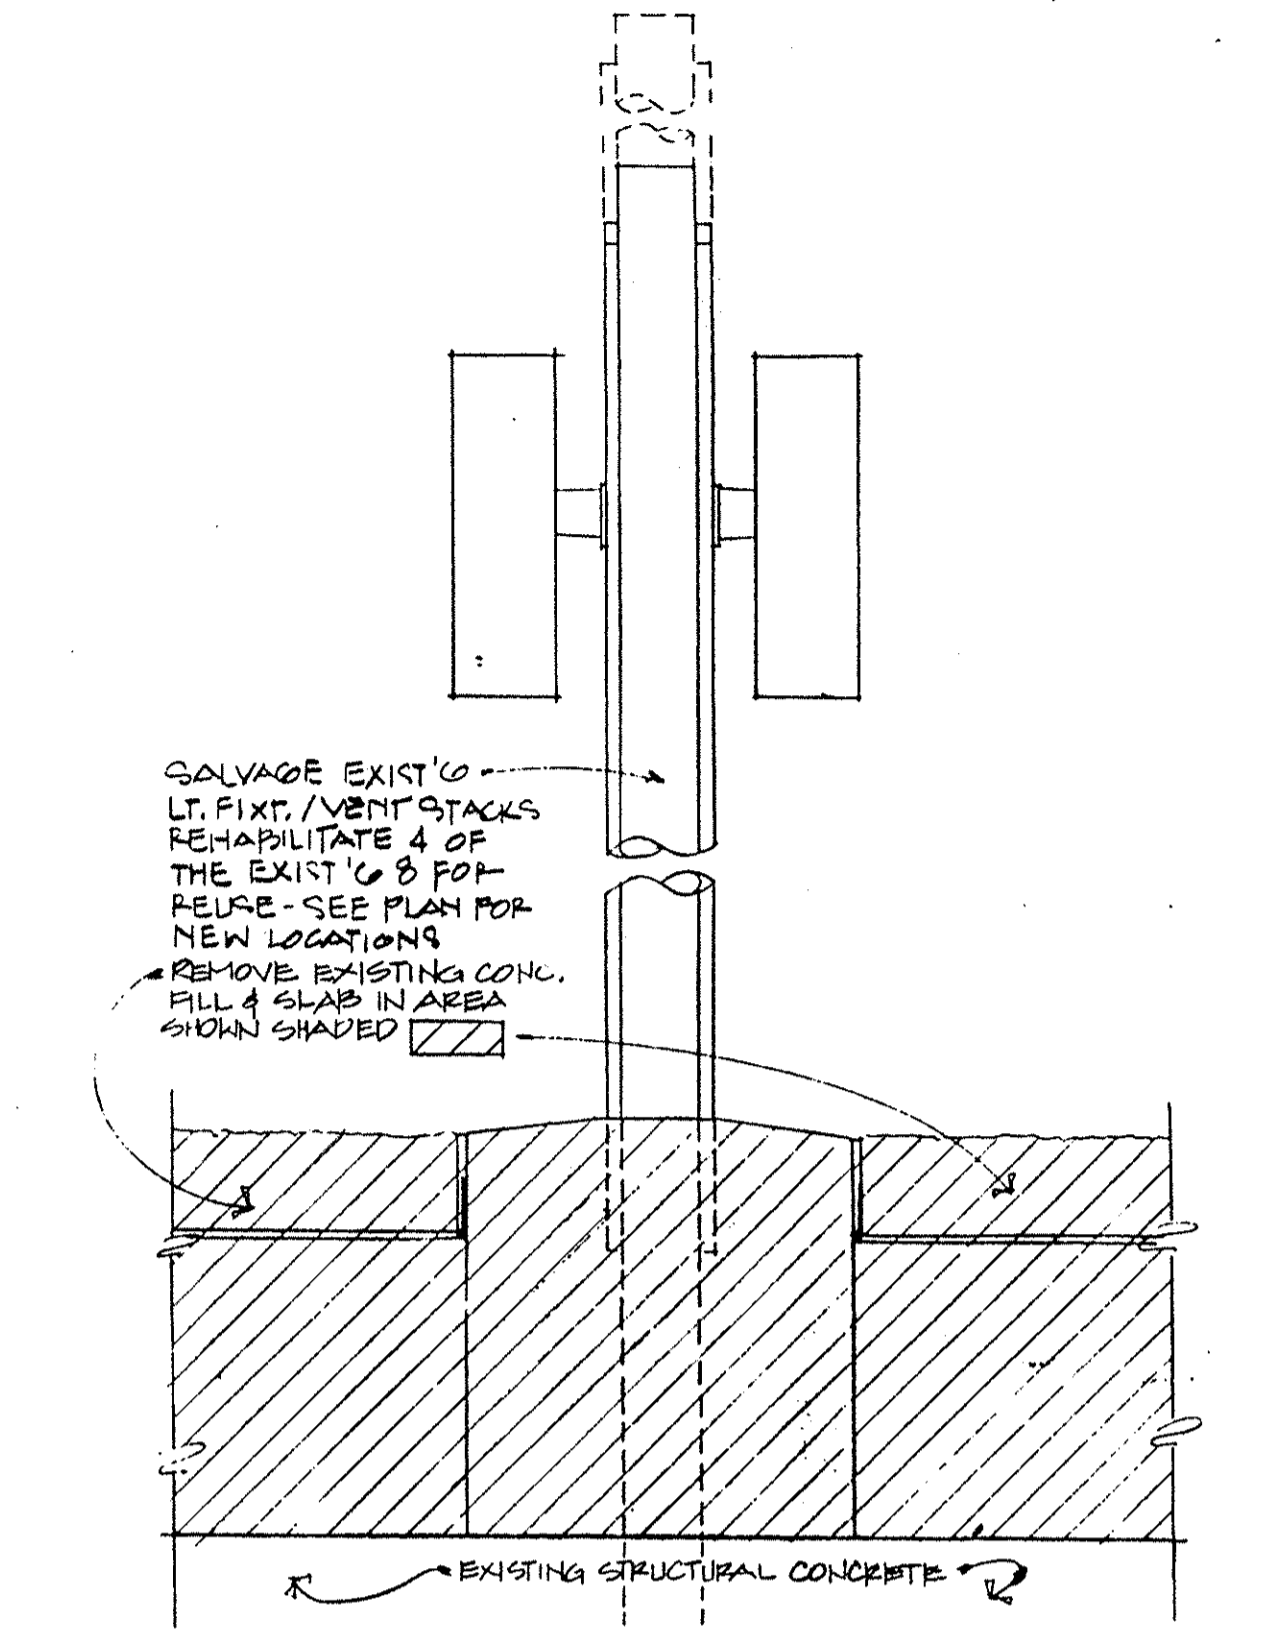


DEMOLITION DTL. @ LIGHT FIXT./VENT. STACK
SCALE : 1" = 1'-0"

NOTE :
REMOVE CONSTRUCTION IN AREA SHOWN SHADED
SEE DTL. B/A-4 FOR NEW EXPANSION JT. CONSTRUCTION.

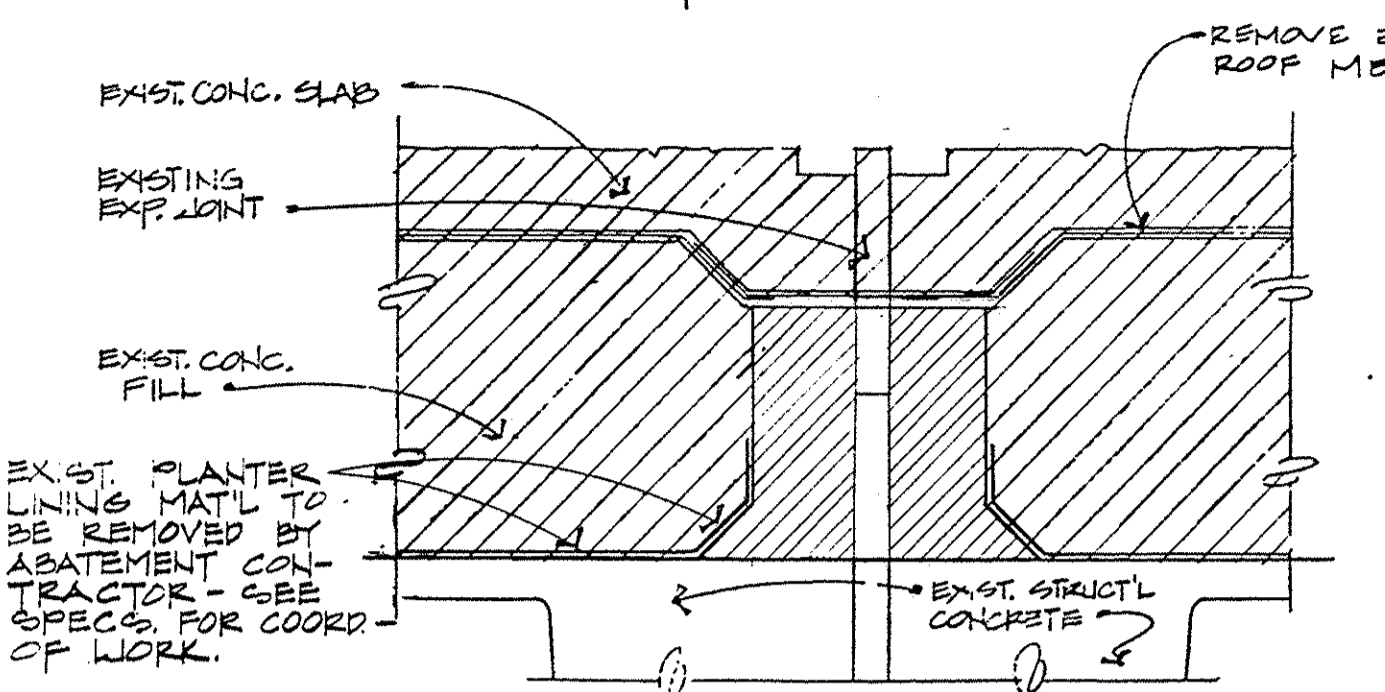

DEMOLITION DETAIL
SCALE : 1" = 1'-0"

NOTE :
REMOVE CONSTRUCTION IN AREA SHOWN SHADED
SEE DTL. B/A-5 FOR NEW PRECAST PRECAST DECK SUPPORT

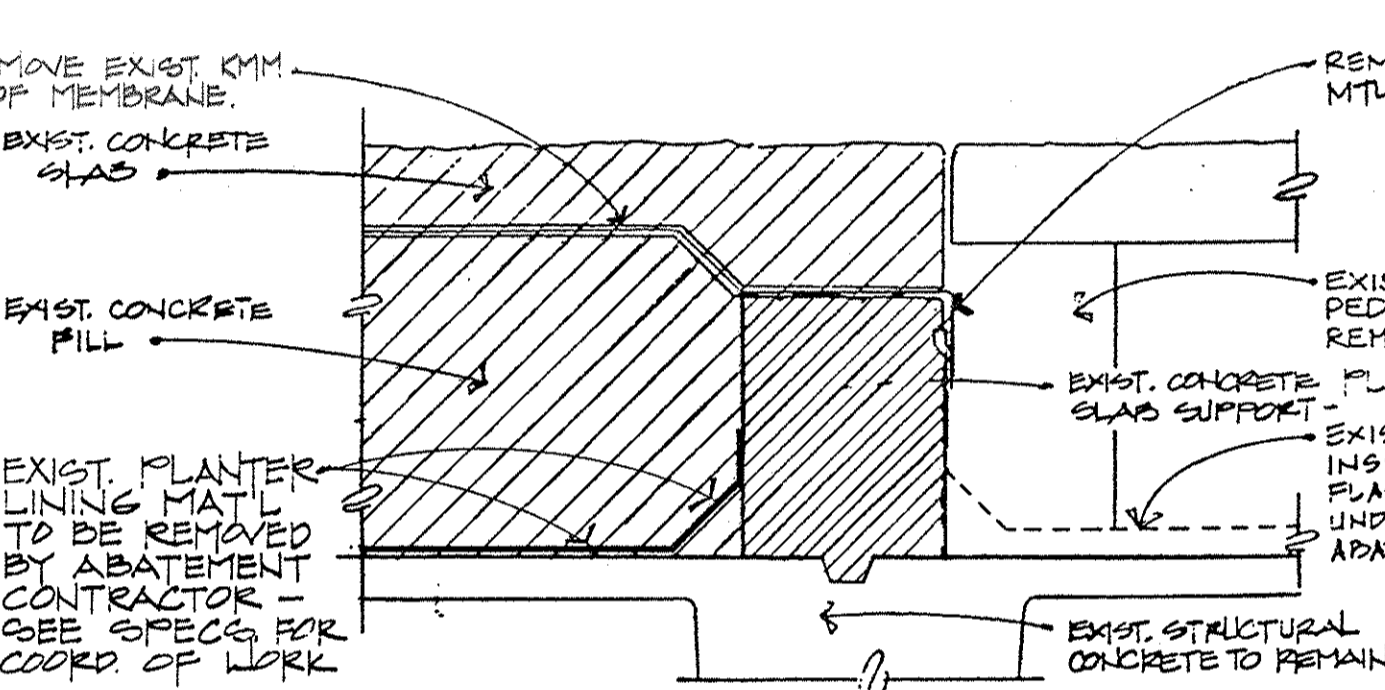

DEMOLITION DETAIL
SCALE : 1" = 1'-0"

GENERAL NOTES

1. GENERAL CONTRACTOR WILL REMOVE EXISTING PRECAST CONCRETE PANELS FOR ASBESTOS ABATEMENT (EXISTING ROOFING MATERIALS) AND RE-ROOFING. STORE PANELS FOR REINSTALLATION AS INDICATED. ASBESTOS ABATEMENT WILL BE BY OTHERS UNDER SEPARATE CONTRACT WITH OWNER. ABATEMENT CONTRACTOR WILL INSTALL TEMPORARY ROOFING OVER STRUCTURAL SLAB. COORDINATE WORK TO INSURE THE PROPER EXECUTION OF THE WORK OF BOTH CONTRACTORS
2. FIELD VERIFY ALL DIMENSIONS.
3. THE CONTRACTOR SHALL INCLUDE IN THE BASE BID - ROOF DRAIN STRAINERS TO REPLACE EXISTING DAMAGED STRAINERS. COST WILL BE ADJUSTED (UP OR DOWN) BASED ON ACTUAL NUMBER REQUIRED, AND AGREED UPON UNIT PRICES.
4. THE CONTRACTOR SHALL INCLUDE IN THE BASE BID FIFTY (50) BRACKETS AND PIPE HANGERS AS SHOWN IN DETAIL H/A-5 TO SUPPORT UNCHARTED PIPES OR CONDUITS. THESE SHALL BE IN ADDITION TO THOSE REQUIRED TO SUPPORT ALL PIPES AND CONDUITS SPECIFICALLY SHOWN ON DRAWINGS. THE CONTRACT SUM WILL BE ADJUSTED (UP OR DOWN) TO REFLECT THE ACTUAL NUMBER OF ADDITIONAL HANGERS REQUIRED ACCORDING TO AGREED UPON UNIT PRICES.

NOTE:
ASBESTOS ABATEMENT: ROSS-FELDMAN ARCHITECTURE, INC. IS IN NO WAY ASSOCIATED WITH IDENTIFICATION OR ABATEMENT OF HAZARDOUS MATERIALS. ROSS-FELDMAN ARCHITECTURE, INC. WILL NOT WARRANT THAT ANY OR ALL HAZARDOUS MATERIALS HAVE OR WILL BE IDENTIFIED OR ABATED. SAID WARRANTY IS THE SOLE RESPONSIBILITY OF THE OWNER'S SEPARATE ASBESTOS ABATEMENT CONTRACT. INFORMATION REGARDING THE SEPARATE CONTRACT FOR ASBESTOS ABATEMENT HAS BEEN PROVIDED BY THE OWNER FROM DOCUMENTS PREPARED BY DAVID C. BANKS, AIA, ARCHITECT, AND DATED APRIL 1992.

**PRECAST CONCRETE PLAZA PANELS
REMOVAL AND STORAGE**

PRECAST CONCRETE PANELS MAY BE TEMPORARILY STACKED ON THE EXISTING PLAZA LEVEL IN ACCORDANCE WITH THE FOLLOWING GUIDELINES:

1. PANELS MAY BE STACKED ANYWHERE ON THE FRAMED PLAZA LEVEL, EXCEPT:
 - A. PANELS MAY NOT BE STACKED ON THE SPANS OVER THE PUBLIC ROADS,
 - B. PANELS MAY NOT BE STACKED WITHIN 10 FT. OF THE PLANTER AREAS, AND,
 - C. PANELS MAY NOT BE STACKED ON THE PORTIONS OF THE PLAZA SLABS WHICH WERE PREVIOUSLY PLANTERS.
2. PANELS MAY BE STACKED TO A HEIGHT OF ONLY TWO (2) PANELS ABOVE PLAZA LEVEL.
3. STACKED PANELS MUST BE SUPPORTED WITHIN 1'-6" OF THEIR CORNERS.
4. STACKED PANELS MUST BE ALIGNED WITH THE SUPPORTING PANELS.
5. THE MAXIMUM ALLOWABLE WHEEL LOAD FOR ANY PARTICULAR TYPE OR MODEL OF CONSTRUCTION EQUIPMENT SHOULD NOT EXCEED 9,000 LBS.
6. THE MAXIMUM ALLOWABLE LOAD PER PANEL IS 20,000 POUNDS.


PRIOR TO CONSTRUCTION, IT IS RECOMMENDED THAT THE CONTRACTOR SUBMIT THE FOLLOWING FOR REVIEW:

- A. THE PLANNED CONSTRUCTION SEQUENCE.
- B. THE LOCATION OF ANY AREAS OF THE PLAZA LEVEL TO BE USED FOR TEMPORARY ON-SITE STACKING OF THE CONCRETE PANELS.
- C. THE WHEEL LOADS AND SPACING FOR ALL CONSTRUCTION EQUIPMENT TO BE USED ON THE PLAZA LEVEL.

IT IS POSSIBLE THAT DURING CONSTRUCTION SOME DETERIORATED CONCRETE ELEMENTS WILL BE DISCOVERED. THEREFORE, IT IS RECOMMENDED THAT CRACKS, SPALLED AREAS, ETC., BE INSPECTED BY THE ARCHITECT TO DETERMINE IF ANY REPAIR IS REQUIRED.


NOTE :
DEMOLITION OF EXIST. FILLED IN PLANTERS TO OCCUR IN 2 STAGES - SEE SPECS. UNDER DEMOLITION.


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DEMOLITION OF EXIST. FILLED IN PLANTERS TO OCCUR IN 2 STAGES - SEE SPECS. UNDER DEMOLITION.

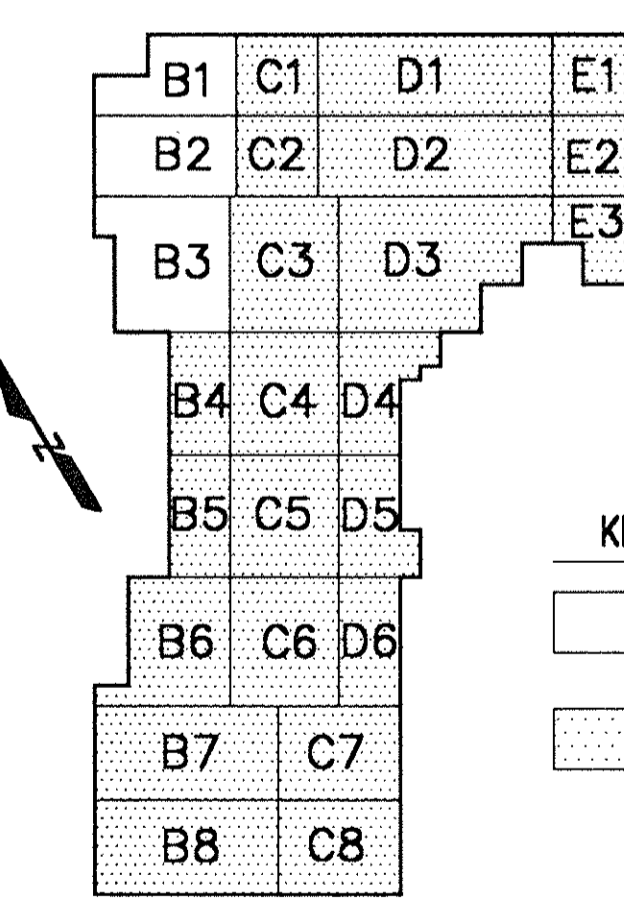

KEY PLAN

REVISIONS	DATE	CAPITAL PLAZA ROOF REPAIR FRANKFORT, KENTUCKY	
1		AS BUILT DATE	
2		DEMOLITION PLAN	
3		COMMONWEALTH OF KENTUCKY FINANCE AND ADMINISTRATION CABINET DEPARTMENT FOR FACILITIES MANAGEMENT DIVISION OF ENGINEERING FRANKFORT, KENTUCKY	
4		DRAWN BY FJK	D-1
5		CHECKED BY JAR, MEH	
6		A & E FILE NO. 9016.1	REVIEWED BY OF ENGR.
7		DATE APRIL 1992	ENGR. FILE NO. M-219-35-B
8		ROSS-FELDMAN ARCHITECTURE, INC. 208 West Main Street Lexington, Kentucky 40507 505-254-4018	
9		APPROVED FOR PROGRAM CONCEPT ONLY DATE 5-12-92 APPROVED FOR PROGRAM CONCEPT ONLY DATE 5-12-92	

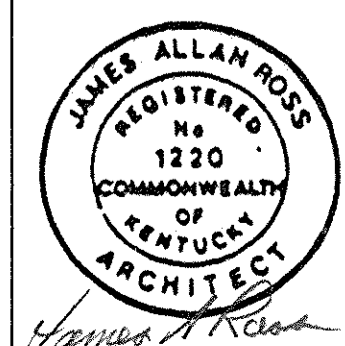

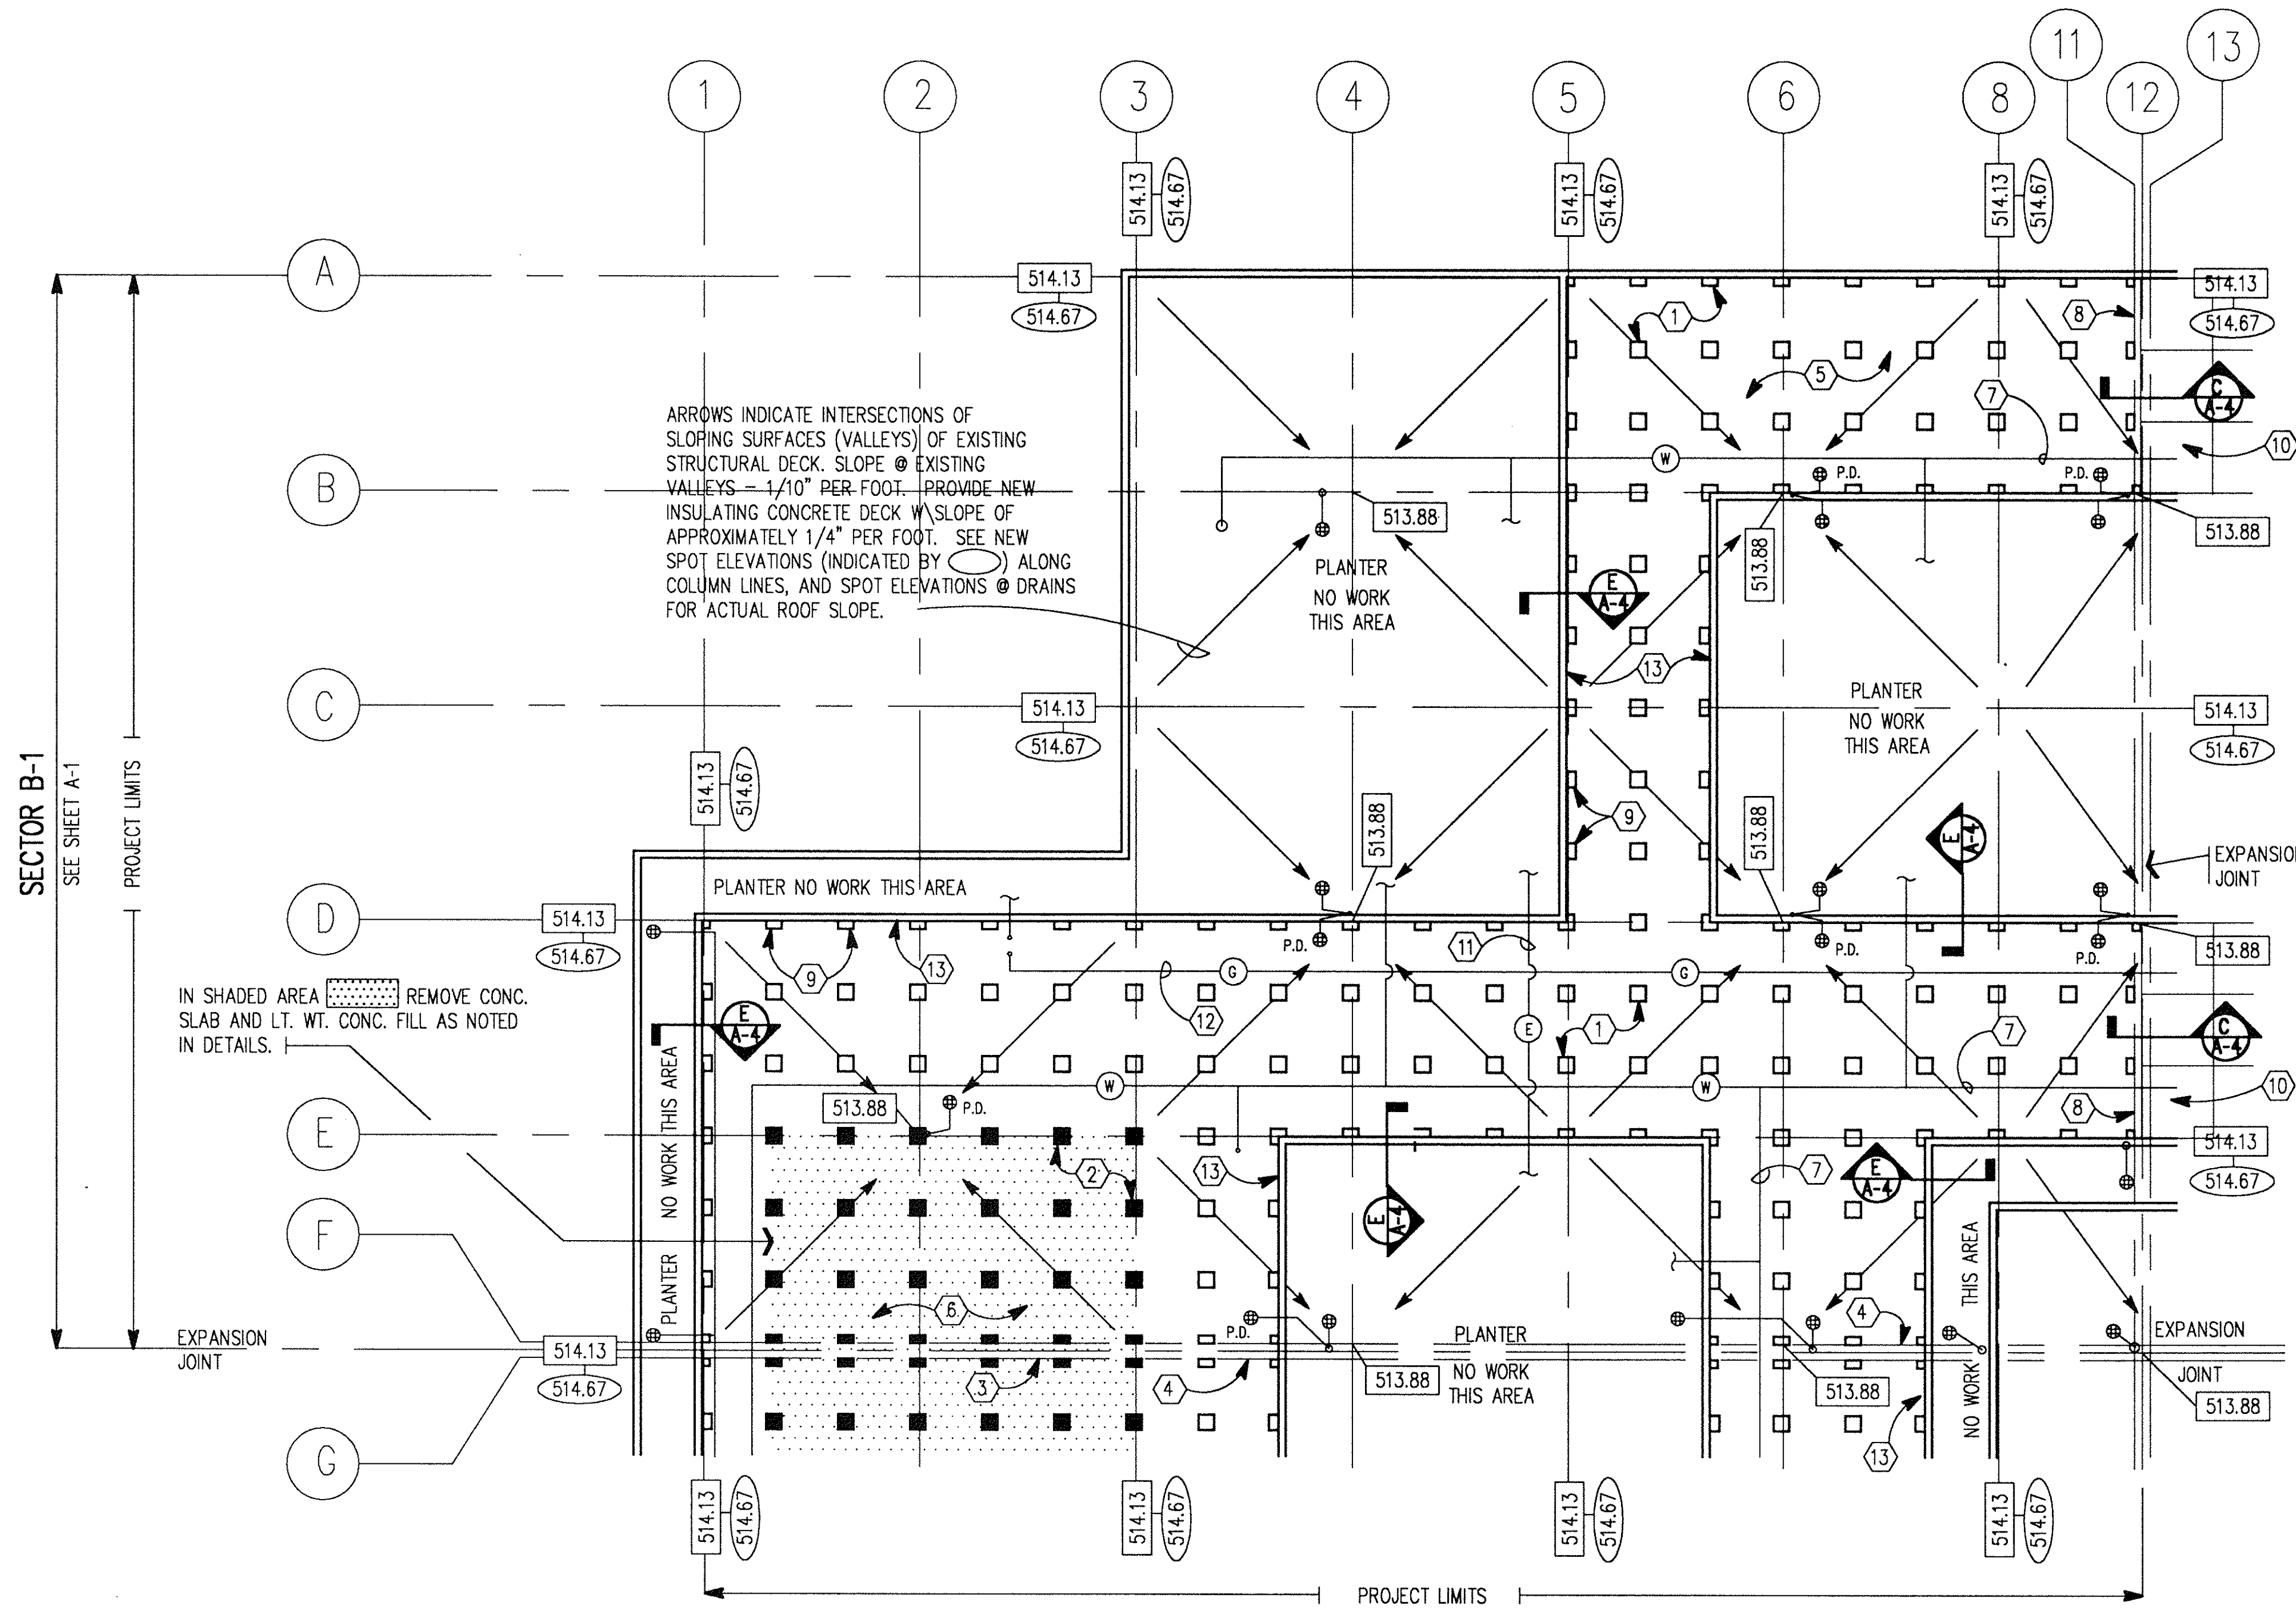

ARROWS INDICATE INTERSECTIONS OF SLOPING SURFACES (VALLEYS) OF EXISTING STRUCTURAL DECK. SLOPE @ EXISTING VALLEYS = 1/10" PER FOOT. PROVIDE NEW INSULATING CONCRETE DECK W/ SLOPE OF APPROXIMATELY 1/4" PER FOOT. SEE NEW SPOT ELEVATIONS (INDICATED BY ○) ALONG COLUMN LINES, AND SPOT ELEVATIONS @ DRAINS FOR ACTUAL ROOF SLOPE.


IN SHADED AREA REMOVE CONC. SLAB AND LT. WT. CONC. FILL AS NOTED IN DETAILS.

NOTE: PRECAST CONCRETE PLAZA PANELS NOT SHOWN FOR CLARITY.

A PARTIAL ROOF PLAN (SECTOR B-1)
A-1 1/16"=1'0"

NOTES

- 1 EXISTING PRECAST CONCRETE PEDESTALS WITH NEW STAINLESS STEEL CAP (TYP.). PEDESTALS ARE TO BE REMOVED FOR ABATEMENT OF ROOFING MATERIAL BELOW (ABATEMENT BY OTHERS) REINSTALL PER DETAIL A/A-5.
- 2 NEW PRECAST CONCRETE PEDESTAL WITH STAINLESS STEEL CAP (SHOWN SHADED). SEE DETAIL B/A-5
- 3 NEW ROOF EXPANSION JOINT SEE DETAIL B/A-4
- 4 EXISTING ROOF EXPANSION JOINT, PROVIDE NEW COPPER CAP, REUSE EXISTING BLOCKING AND STEEL ANGLE SUPPORT UNLESS DAMAGED. SEE DETAIL B/A-4 SIM.
- 5 TYPICAL ROOF CONSTRUCTION. SEE DETAIL A/A-4.
- 6 IN AREAS SHOWN SHADED, PROVIDE NEW PRECAST CONCRETE PLAZA PANELS. SEE DETAIL D/A-4 FOR TYPICAL PANEL DESIGN.
- 7 EXISTING WATER PIPING BETWEEN PLAZA ROOF AND DECK TO REMAIN. PROVIDE NEW ANCHOR TO STAINLESS STEEL CAP AS SHOWN IN DETAIL H/A-5. EXISTING WATERLINES ARE INSTALLED WITH POSITIVE SLOPE FOR SEASONAL BACK DRAINING. FINAL WORK SHALL MAINTAIN/ PROVIDE POSITIVE SLOPE.
- 8 EXISTING ROOF EXPANSION JOINT AT BOUNDARY OF WORK. SEE DETAIL C/A-4.
- 9 PRECAST CONCRETE PEDESTAL AT PLANTER WALL (OR OTHER VERTICAL SURFACE). SEE DETAIL D/A-5
- 10 REMOVE AND REPLACE EXISTING PANELS AS REQUIRED FOR WORK ON EXPANSION JOINTS.
- 11 ELECTRICAL CONDUIT BETWEEN PLAZA ROOF AND DECK, PROVIDE NEW ANCHOR TO STAINLESS STEEL CAP AS SHOWN IN DETAIL H/A-5. VERIFY EXTENT OF CONDUIT.
- 12 EXISTING GAS LINE BETWEEN PLAZA ROOF AND DECK. COORDINATE SHUT-OFF WITH STATE WHEN WORKING IN THIS AREA.
- 13 CLEAN CONCRETE FACE OF ALL PLANTERS ADJACENT TO THE PRECAST PLAZA PANELS WITHIN THE LIMITS OF THE CONTRACT.

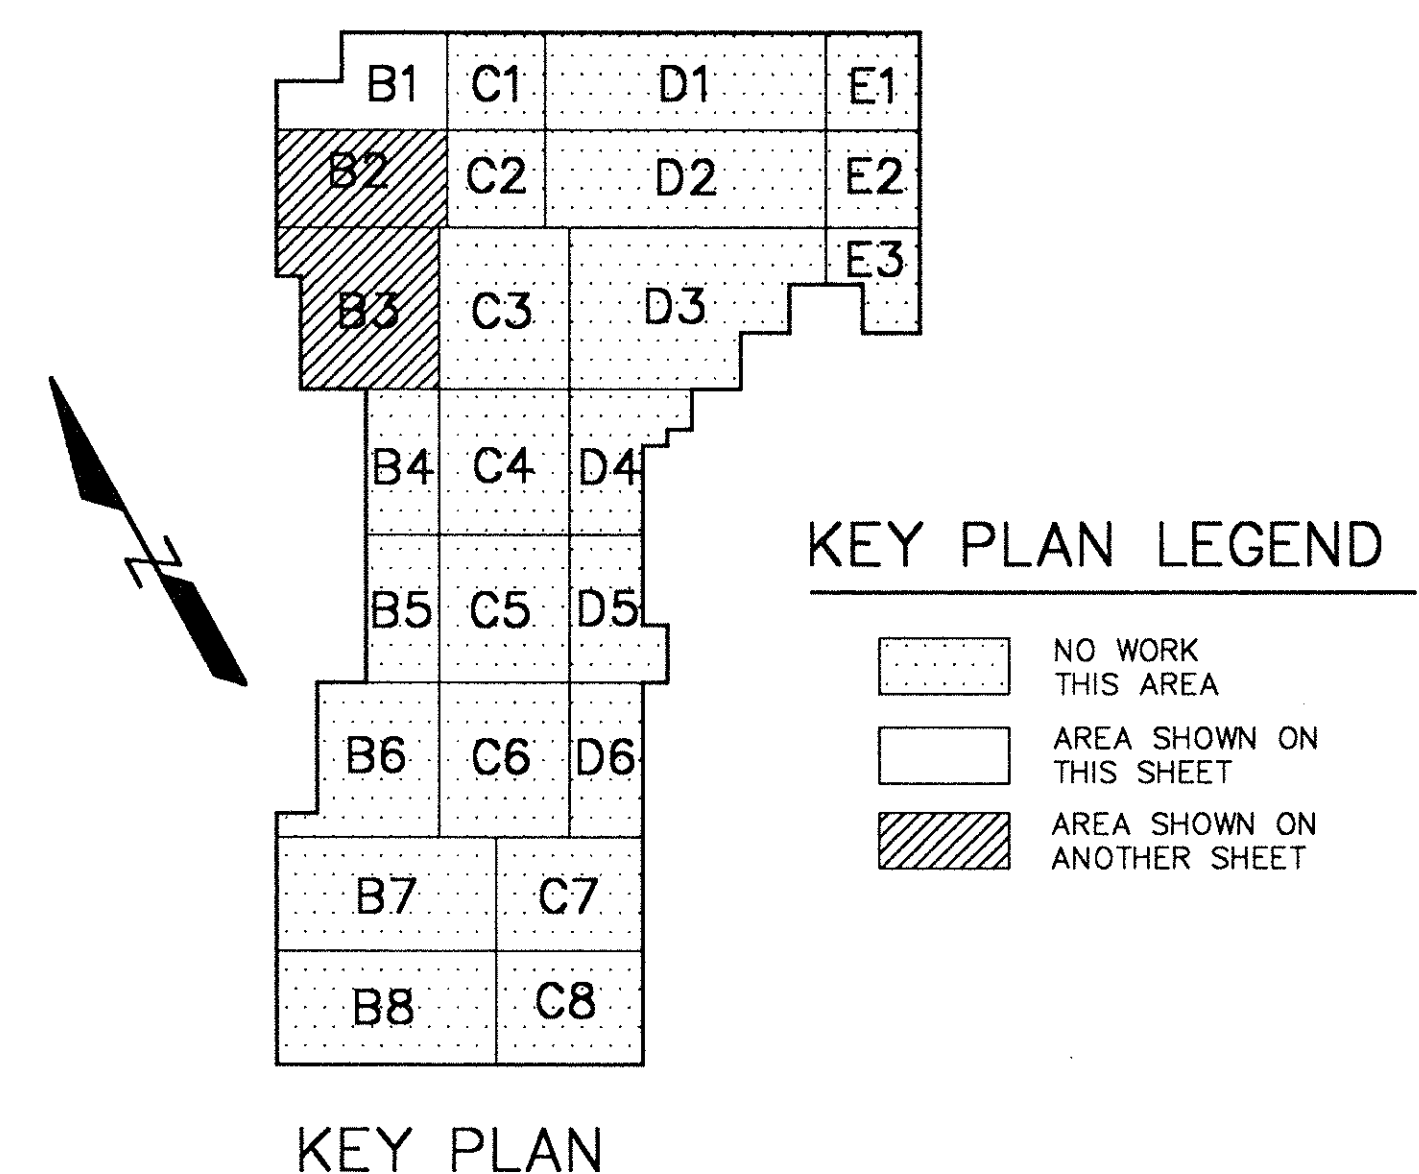

- SYMBOLS KEY**
- P.D. PLAZA DRAIN TO REMAIN
 - DENOTES ELEVATION OF EXISTING STRUCTURAL CONCRETE SLABS.
 - DENOTES ELEVATIONS OF NEW ROOF CONSTRUCTION - SEE PLAN FOR TYP. HIGH POINTS. SEE DETAIL H/A-4 FOR ROOF ELEVATIONS AT LOW POINTS.


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3. SEE NOTE 3 ON A-3.
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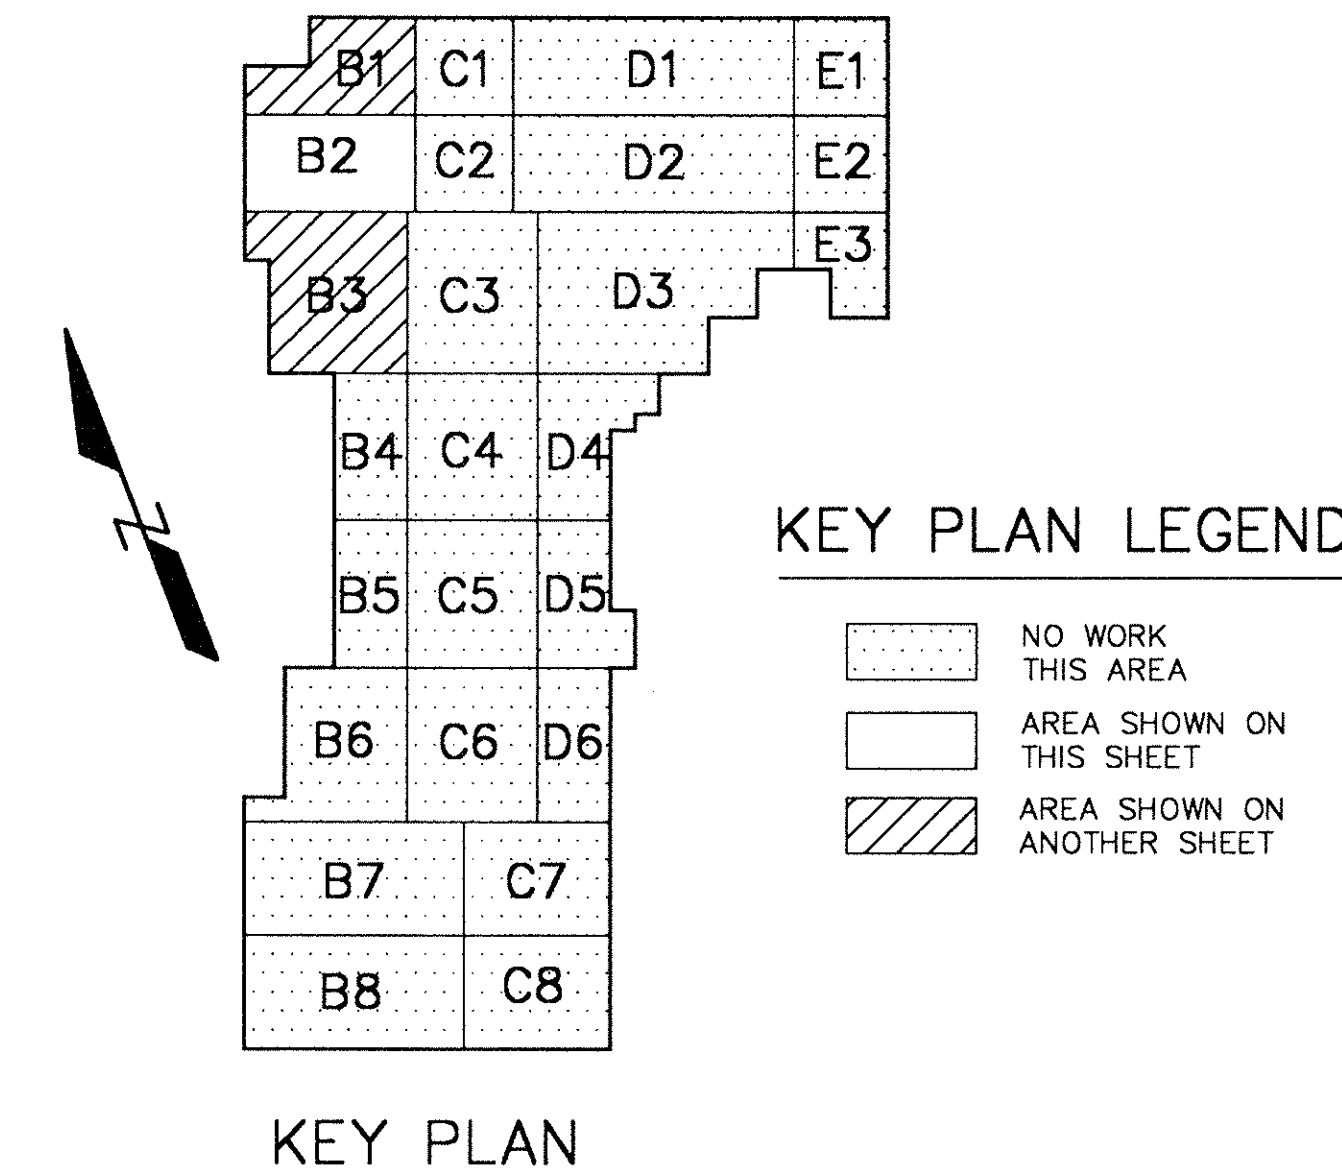
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1			AS BUILT DATE	PARTIAL ROOF PLAN
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- 8 PRECAST CONCRETE PEDESTAL AT PLANTER WALL (OR OTHER VERTICAL SURFACE). SEE DETAIL D/A-5
- 9 ELECTRICAL CONDUIT BETWEEN PLAZA ROOF AND DECK, PROVIDE NEW ANCHOR TO STAINLESS STEEL CAP AS SHOWN IN DETAIL H/A-5. VERIFY EXTENT OF CONDUIT.
- 10 RELOCATE EXISTING ROOF DRAIN - PROVIDE ROUGH OPENING IN CONCRETE SLAB - COORDINATE SIZE WITH DRAIN. CONNECT 4" STORM LINES TO EXISTING STORM LINES. SEE DETAIL F/A-4 FOR DRAIN ACCESS PANEL TO BE LOCATED ABOVE DRAIN IN PAVING PANEL - CONDITION AT EXISTING DRAIN (DENOTED P.D. ON ROOF PLAN) IS SIMILAR.
- 11 REMOVE EXISTING DRAIN AND RELOCATE AS SHOWN. FILL IN CONCRETE SLAB.
- 12 RELOCATE EXISTING LIGHT FIXTURE/VENT STACK, EXTEND VENT PIPING FROM BELOW STRUCTURAL SLAB - SLOPE MINIMUM 1/8" PER FOOT TO NEW LOCATION SEE DETAIL C/A-5.
- 13 EXISTING FLAGPOLES TO REMAIN.
- 14 REMOVE AND REPLACE EXISTING PRECAST CONCRETE BENCHES AS REQUIRED BY WORK IN THIS AREA.
- 15 CLEAN CONCRETE FACE OF ALL PLANTERS ADJACENT TO THE PRECAST PLAZA PANELS WITHIN THE LIMITS OF THE CONTRACT.



A PARTIAL ROOF PLAN (SECTOR B-2)
A-2 1/16"=1'0"




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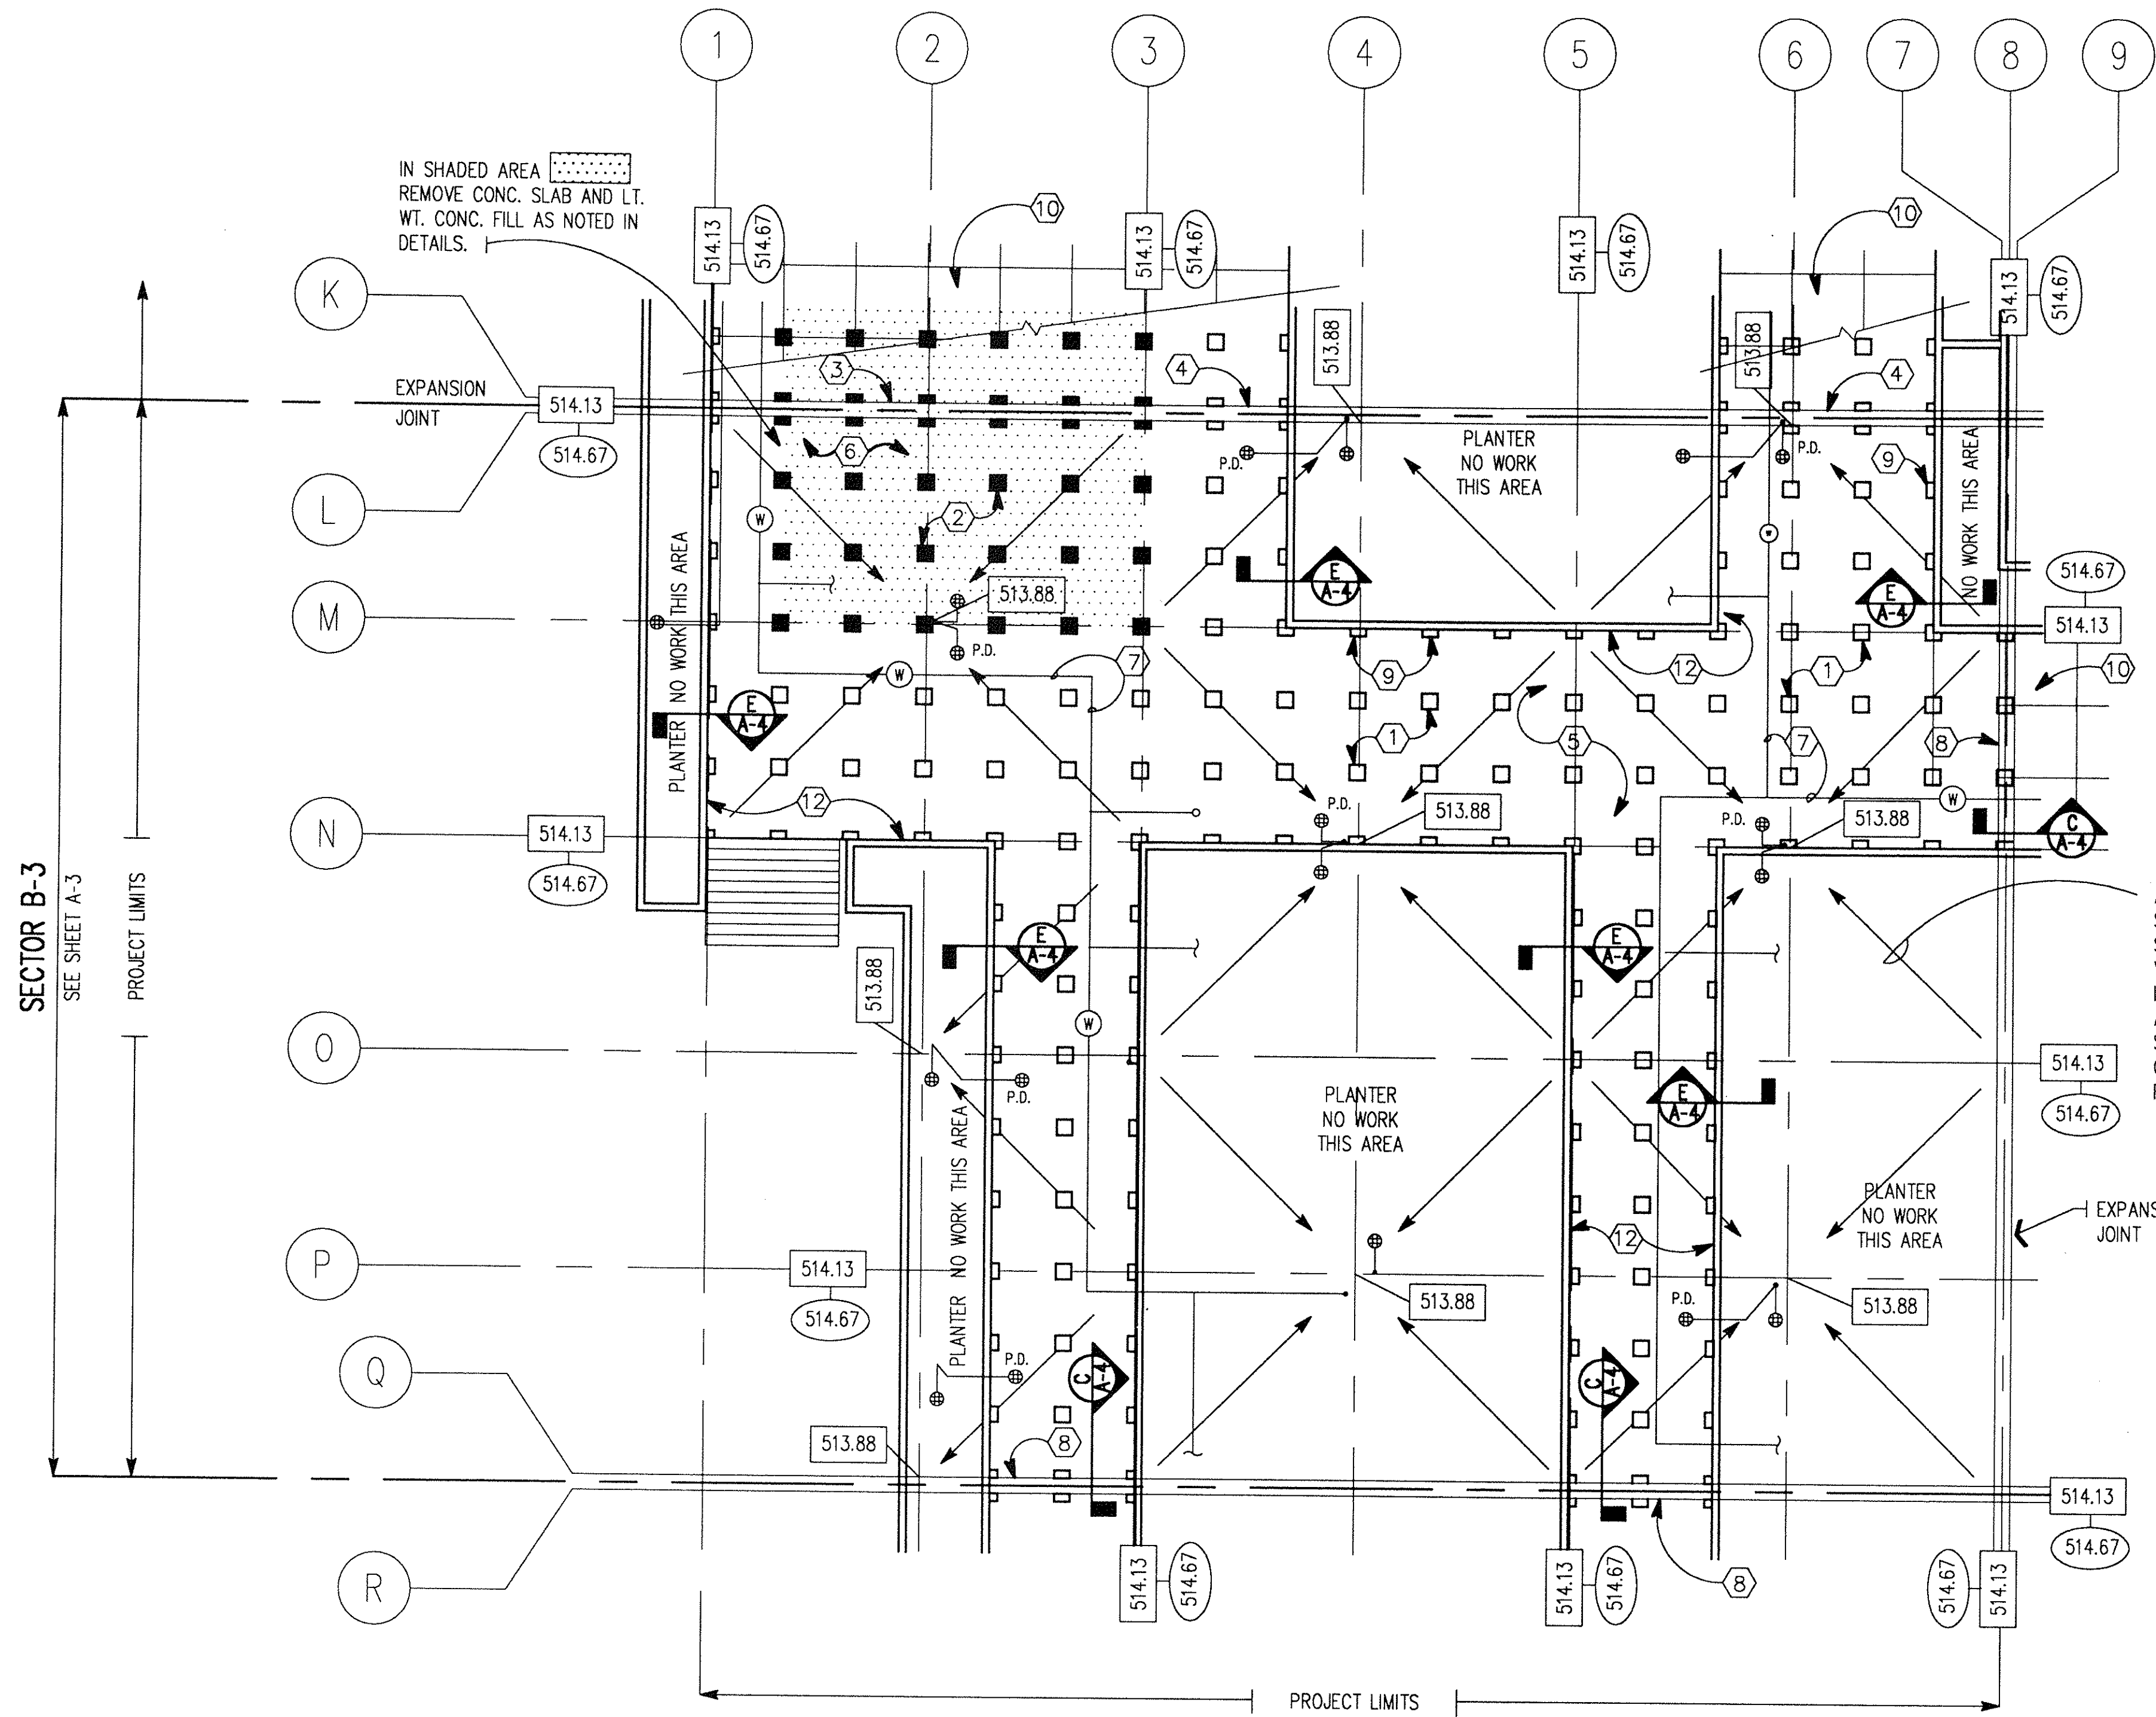
SYMBOLS KEY

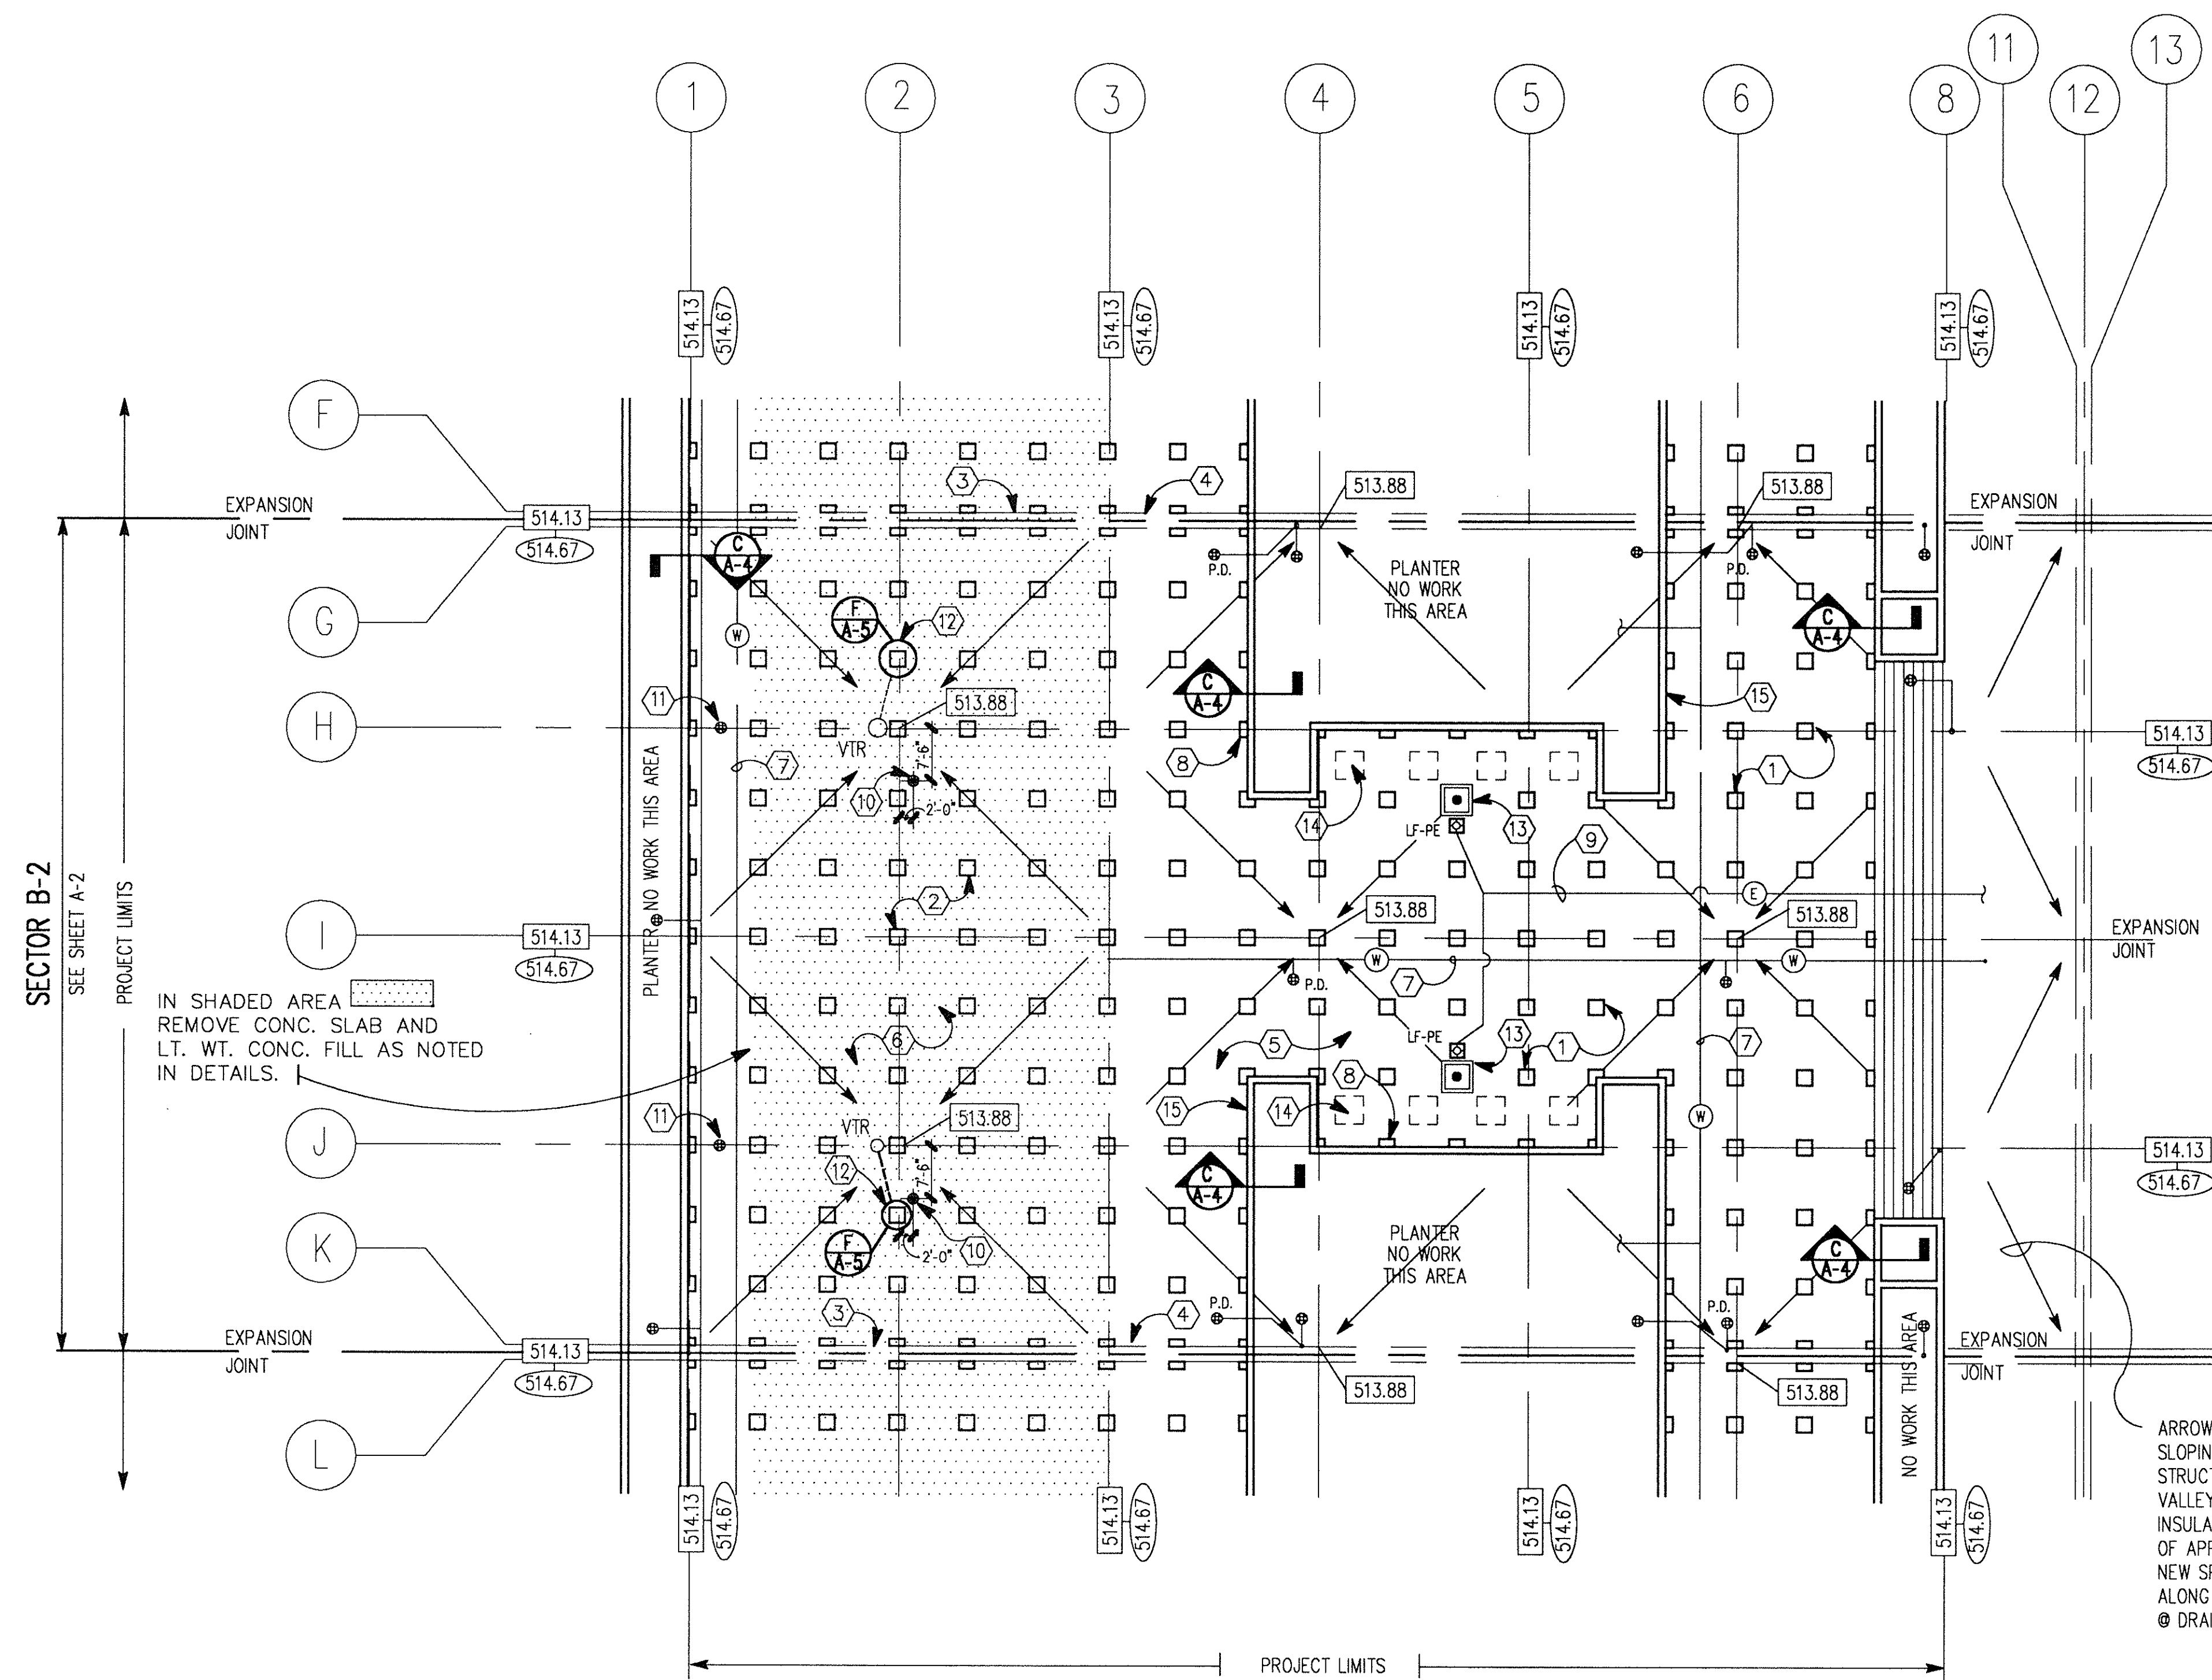- P.D. PLAZA DRAIN TO REMAIN
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7		DIVISION OF ENGINEERING	APPROVED FOR PROGRAM CONCEPT ONLY
8		DATE	6-12-92
9		DATE	5-12-92




CRA-739

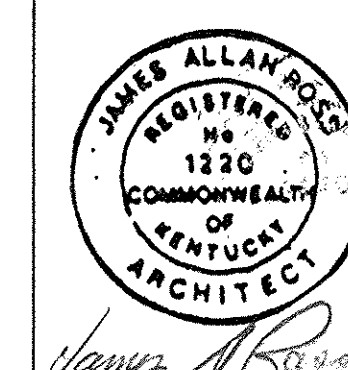

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KEY PLAN LEGEND

KEY PLAN

A PARTIAL ROOF PLAN (SECTOR B-3)
A-3 1/16"=1'0"

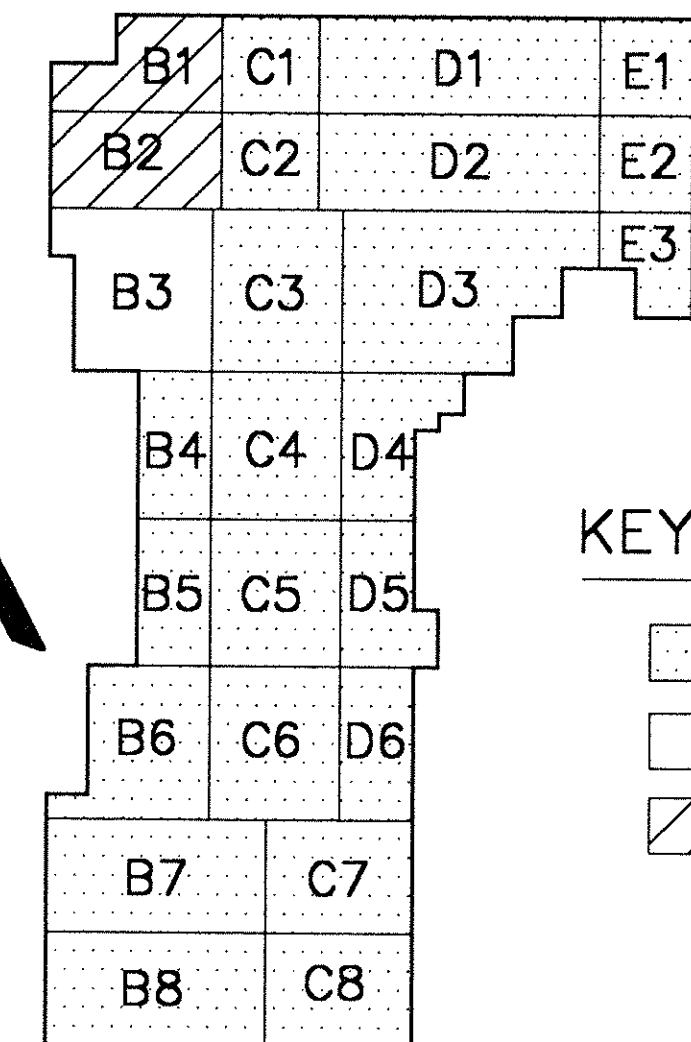
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2. FIELD VERIFY ALL DIMENSIONS.
3. CLEAN OUT ALL LEADERS FROM ALL PLAZA DRAINS AND ENSURE THAT ALL DRAINS AND LEADERS FUNCTION PROPERLY.
4. THE CONTRACTOR SHALL INCLUDE IN THE BASE BID - ROOF DRAIN STRAINERS TO REPLACE EXISTING DAMAGED STRAINERS. COST WILL BE ADJUSTED (UP OR DOWN) BASED ON ACTUAL NUMBER REQUIRED, AND AGREED UPON UNIT PRICES.
5. THE CONTRACTOR SHALL INCLUDE IN THE BASE BID FIFTY (50) BRACKETS AND PIPE HANGERS AS SHOWN IN DETAIL H/A-5 TO SUPPORT UNCHARTED PIPES OR CONDUITS SPECIFICALLY SHOWN ON DRAWINGS. THE CONTRACT SUM WILL BE ADJUSTED (UP OR DOWN) TO REFLECT THE ACTUAL NUMBER OF ADDITIONAL HANGERS REQUIRED ACCORDING TO AGREED UPON UNIT PRICES.


REVISIONS	DATE	CAPITAL PLAZA ROOF REPAIR (PHASE 2) FRANKFORT, KENTUCKY	
1		AS BUILT DATE	PARTIAL ROOF PLAN
2		DRAWN BY	FJK
3		CHECKED BY	JAR, MEH
4		A & E FILE NO.	9016.1
5		DATE	APRIL 1992
6		AGENCY	COMMONWEALTH OF KENTUCKY FINANCE AND ADMINISTRATION CABINET DEPARTMENT FOR FACILITIES MANAGEMENT DIVISION OF ENGINEERING FRANKFORT, KENTUCKY
7		DRAWING NO.	A-3
8		REVIEWED	DATE 5-12-92
9		ENGR. FILE NO.	M-219-35-B



APPROVED FOR PROGRAM CONCEPT ONLY
 AUTHORIZED AGENT: *James Allan Ross*
 DATE: 5-12-92
 DIVISION OF ENGINEERING
 APPROVED FOR PROGRAM CONCEPT ONLY
 AUTHORIZED AGENT: *Robert W. Schade*
 DATE: 5-12-92

TYPICAL ROOF CONSTRUCTION:

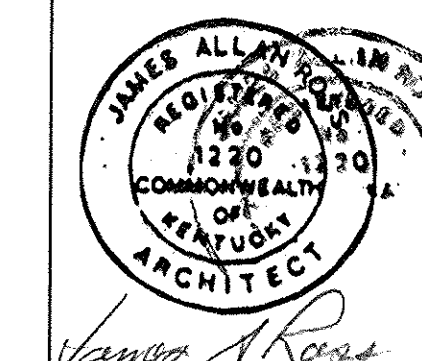NOTE: ROOF THICKNESS VARIES. COORD. SLOPE WITH ELEVATIONS SHOWN ON PLAN AND DTL. H/A-4

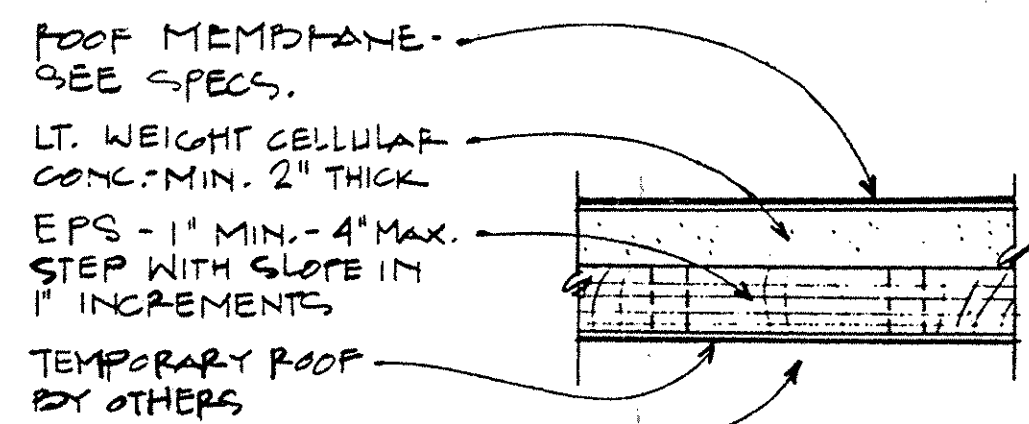

EXISTING STRUCT'L CONC. SLAB

SCALE: 1/2" = 1'-0"

A
A-4


NOTE: AT EXIST. EXP. JOINTS, REUSE EXIST. 2x12 BLOCKING & STL. ANGLE SUPPORT - REPLACE DAMAGED BLOCKING AS NEEDED.

PRECAST CONC. PANEL - SEE PLANS WHERE NEW PANELS ARE TO OCCUR.
 PRECAST CONC. PEDESTALS BEYOND
 20' OZ. COPPER CAP
 2x12 TYP. SECURE TO EA. LEG OF 2x12 3/16" Ø BOLTS
 CONT. CANT STRIP
 TYP. ROOF CONSTRUCTION SEE DTL. A/A-4
 TEMPORARY ROOF BY OTHERS
 EXIST'G STRUCT'L CONC. SLAB
 5' x 5' x 3/16" L 12" LENGTHS @ 4' O.C. PARALLEL TO CONC. 2" FROM EA. END
 DRAPE BLDG. PAPER INTO JOINT & FILL W/ BATT INSULATION

NEW EXPANSION JNT. DTL.

SCALE: 1/2" = 1'-0"


B
A-4

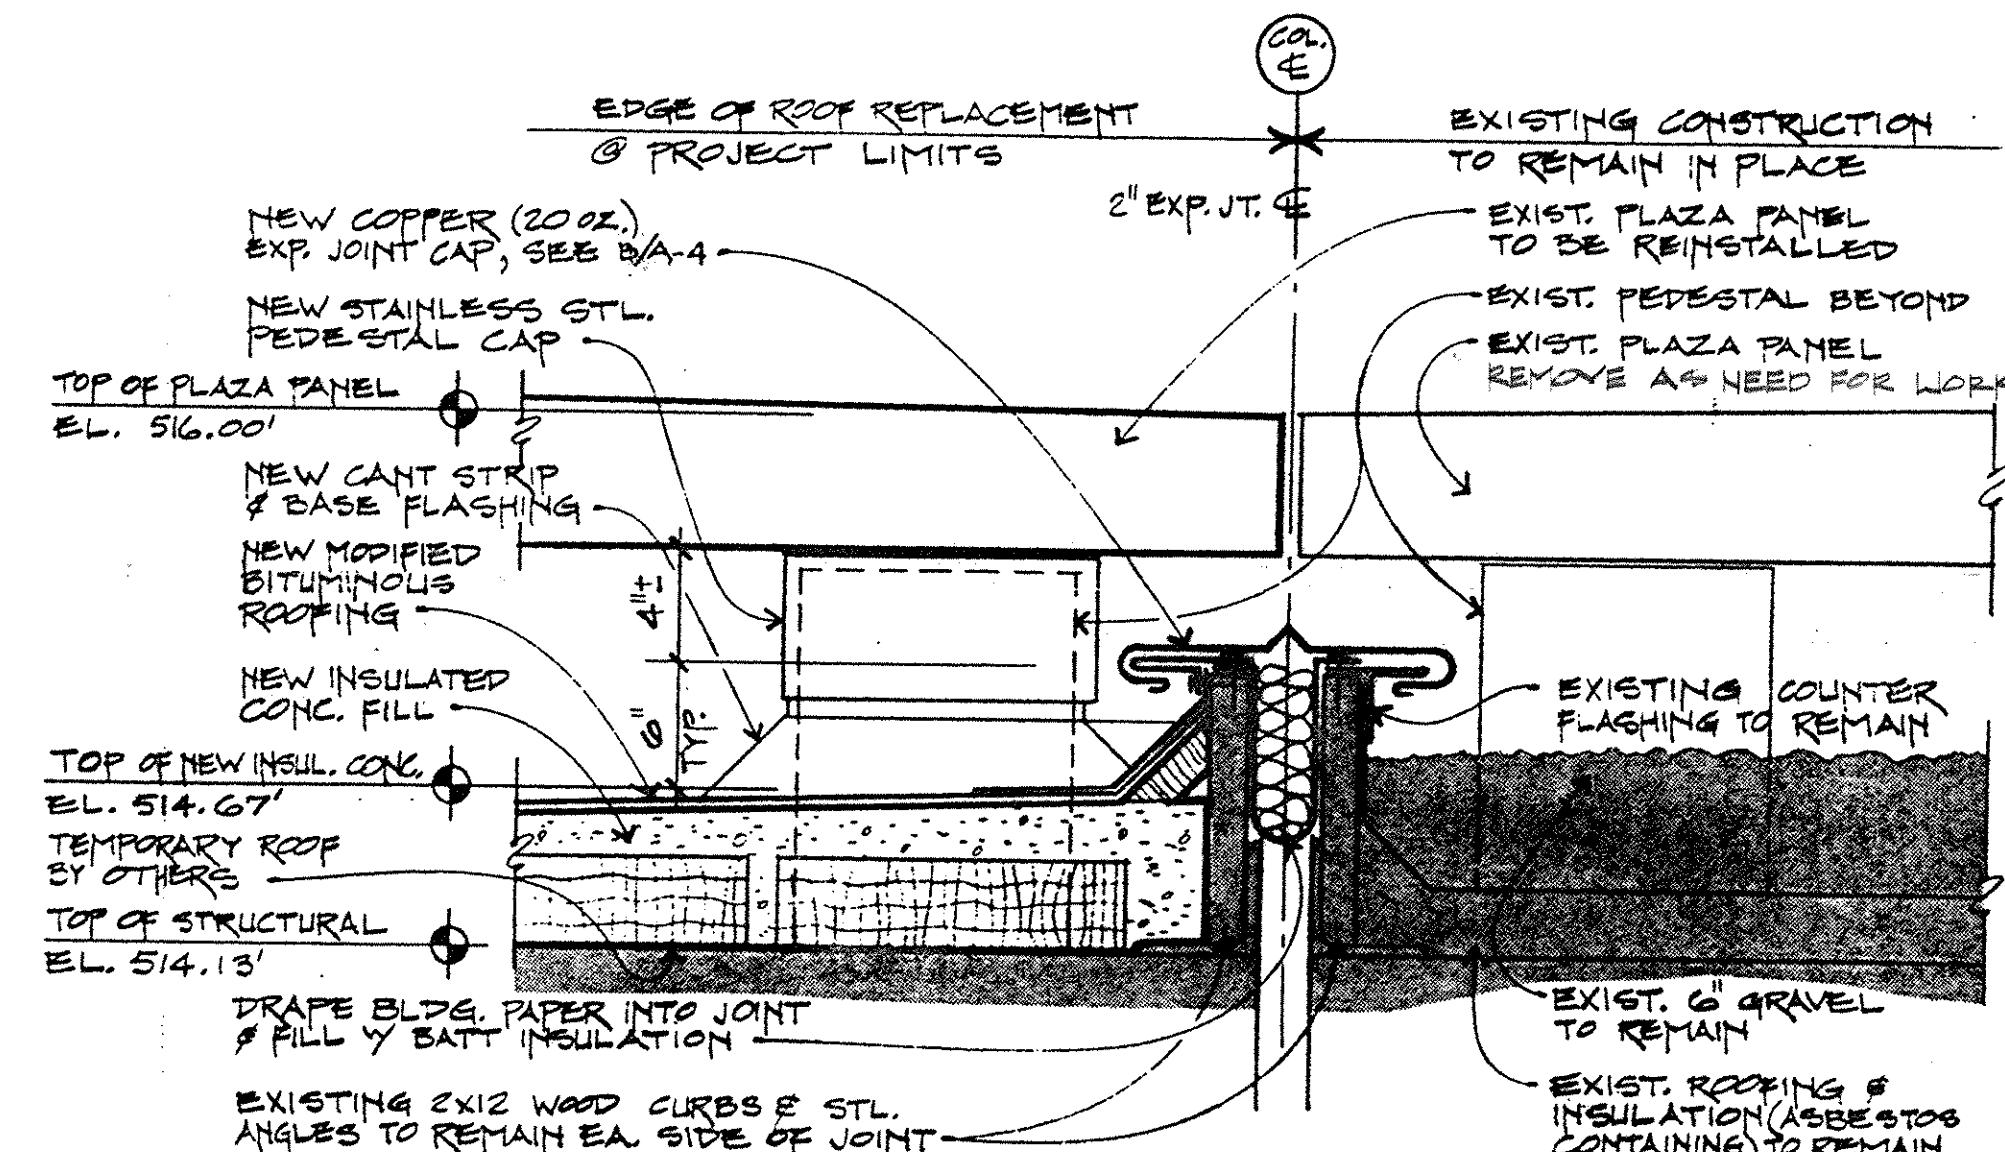

EXPANSION JOINT DETAIL @ PROJECT LIMITS

SCALE: 1/2" = 1'-0"


C
A-4

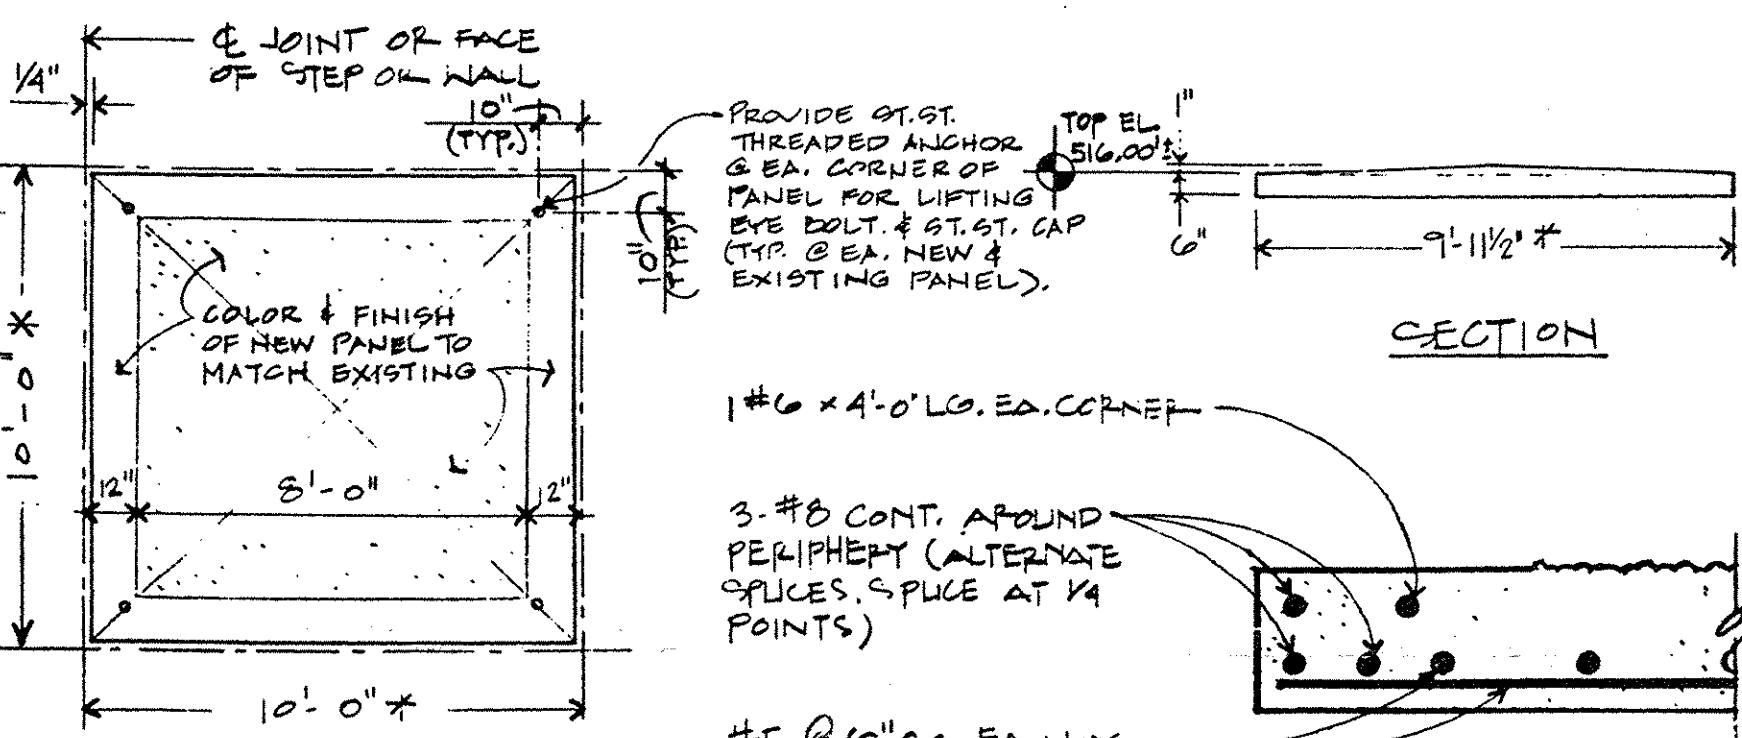

*TYPICAL DIMENSIONS. SEE PLANS FOR VARIATIONS IN SIZE OF PRECAST PAVING PANELS

PRECAST PLAZA PAVING PANELS


D
A-4

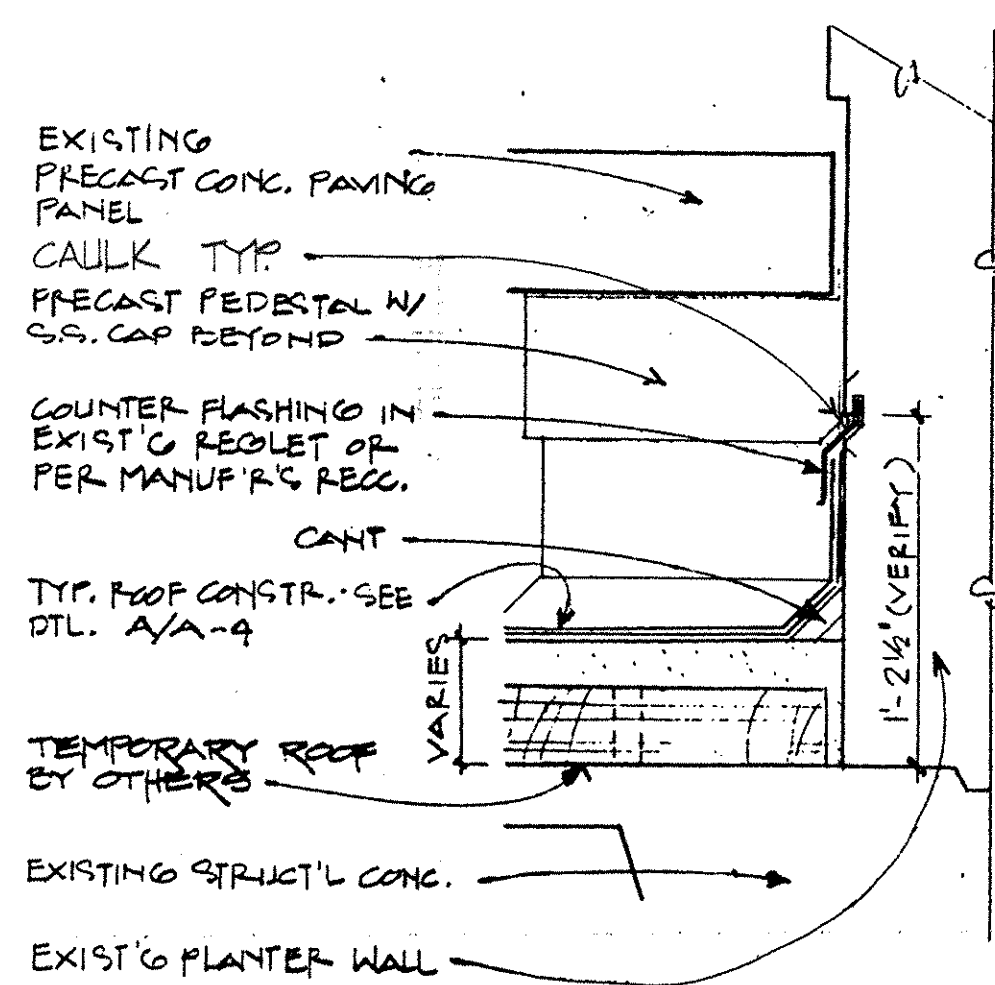

TYP. ROOF TERMINATION

SCALE: 1/2" = 1'-0"


E
A-4

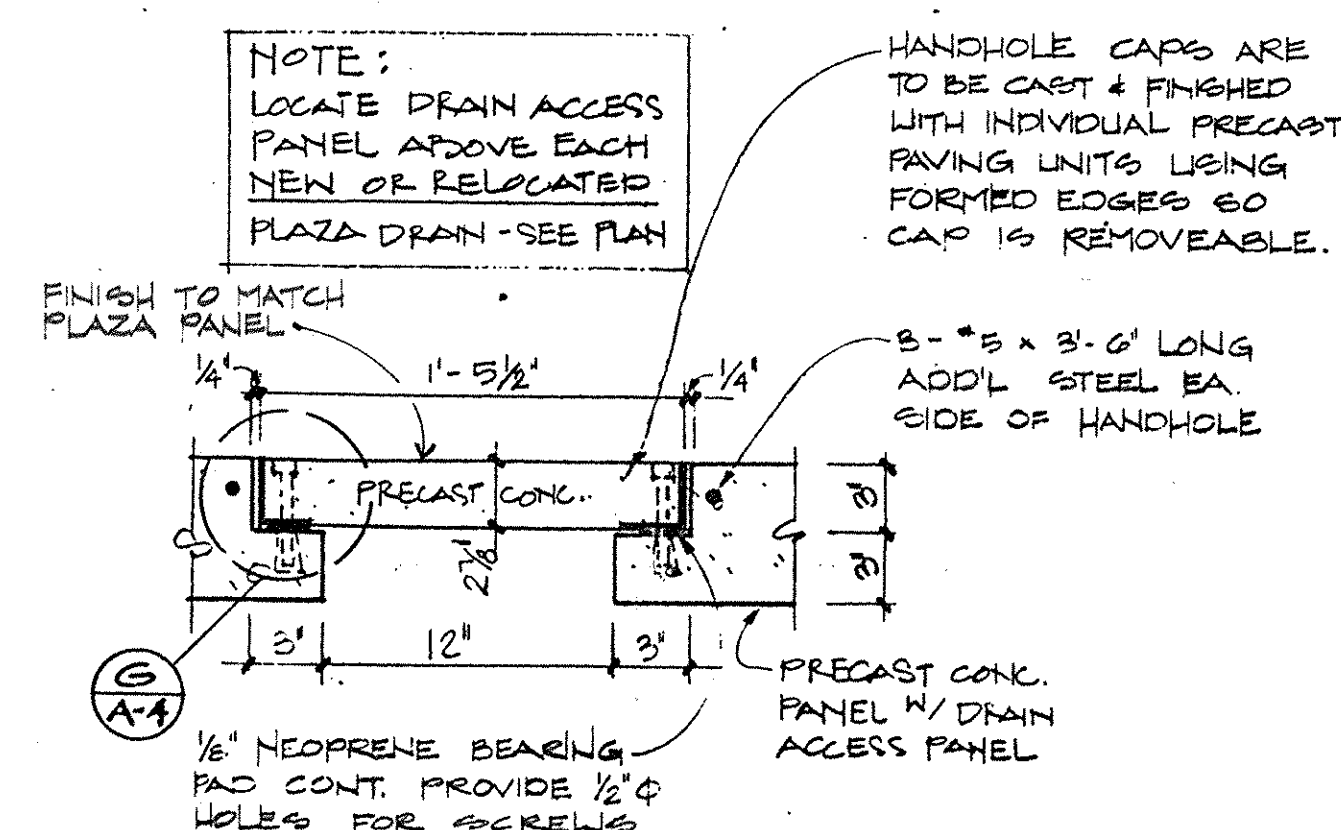

DRAIN ACCESS PANEL

SCALE: 1/2" = 1'-0"


F
A-4

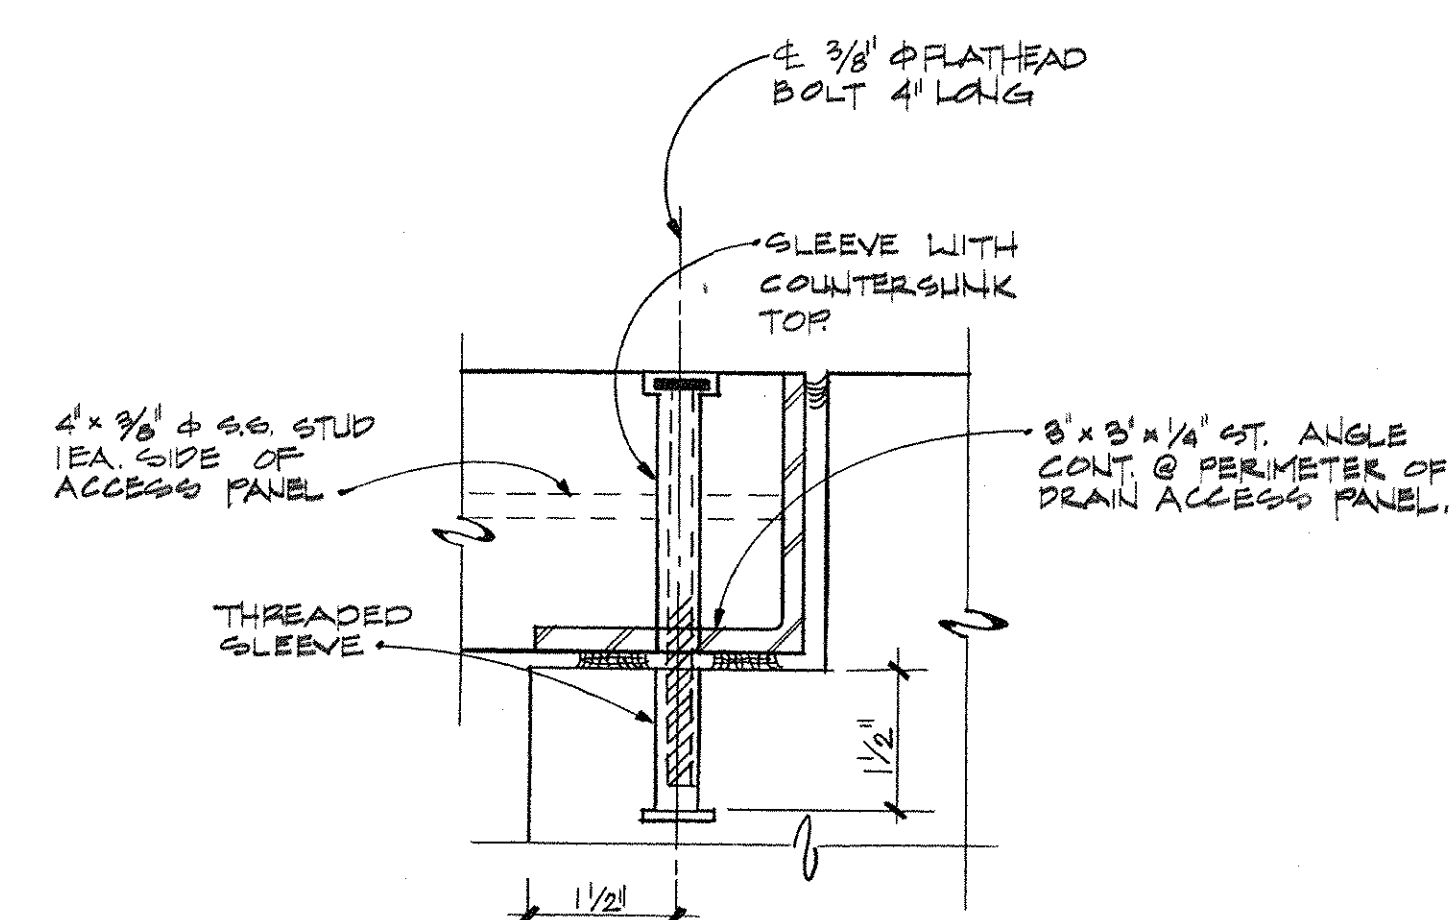

DETAIL

SCALE: HALF SIZE


G
A-4

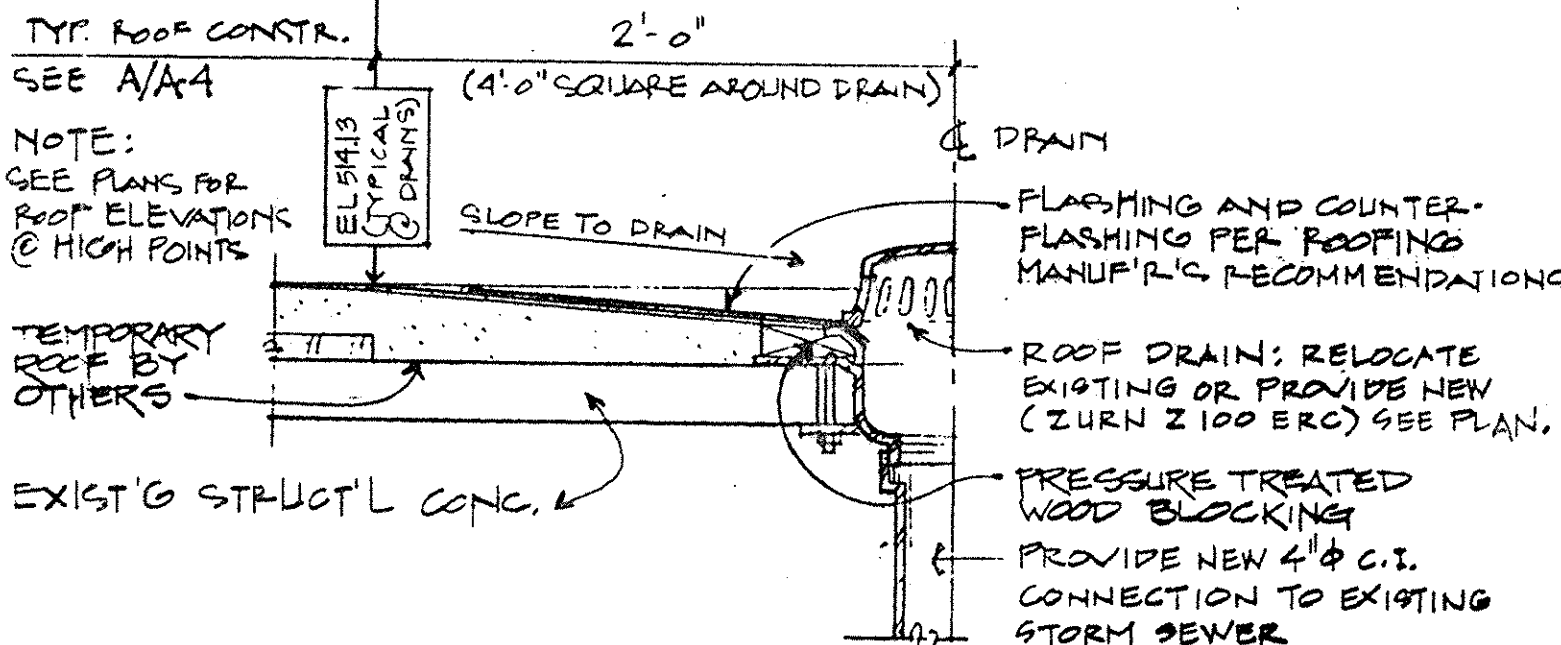

ROOF DRAIN DTL.

SCALE: 1/2" = 1'-0"


H
A-4

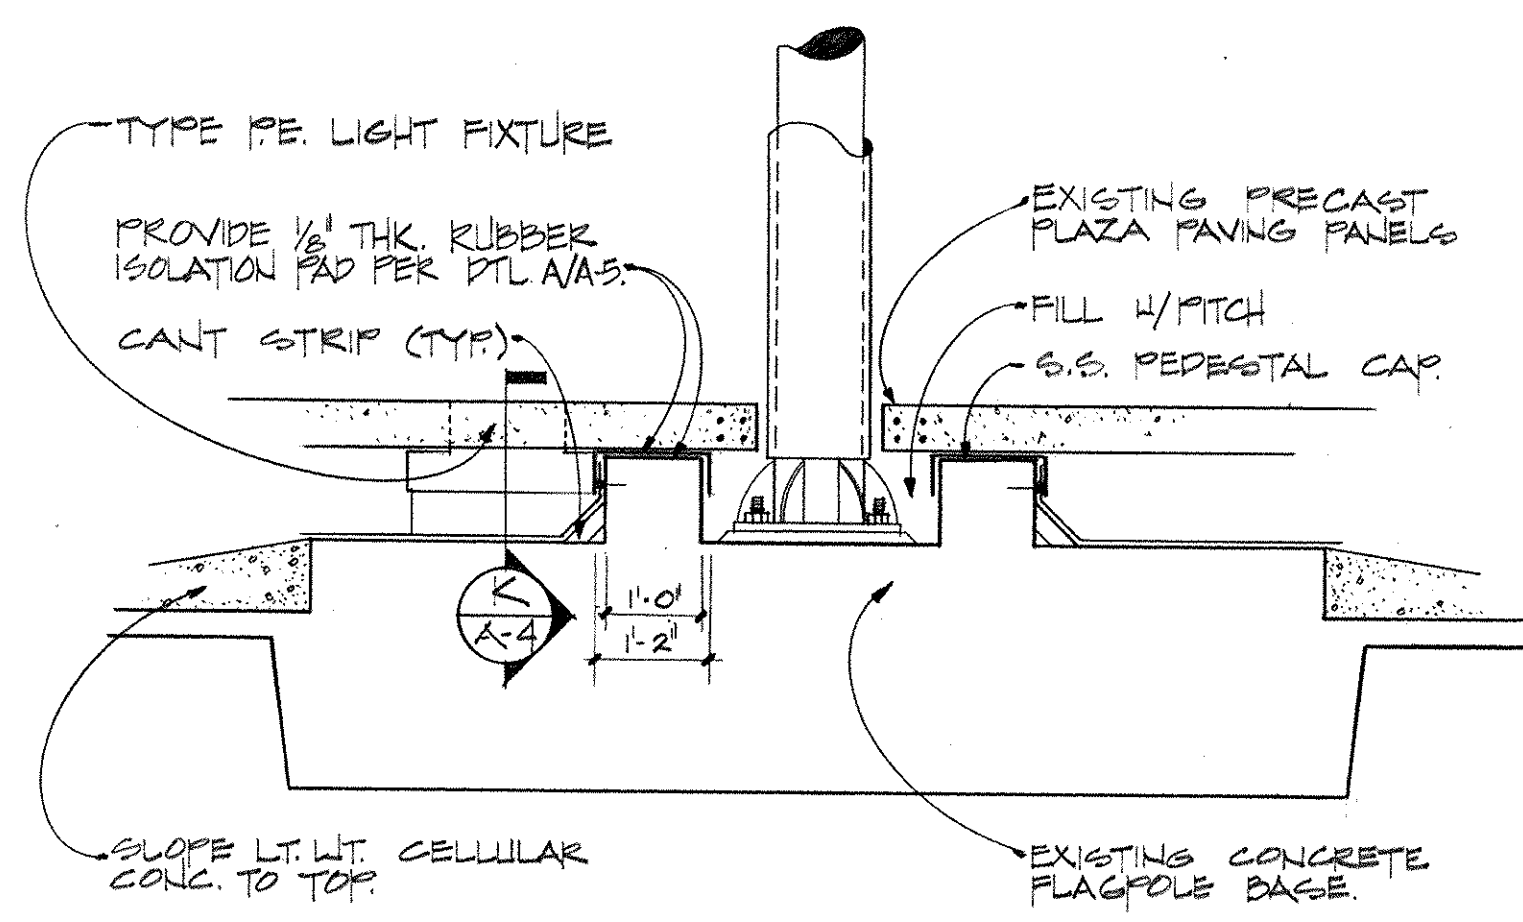

FLAGPOLE BASE DETAIL

SCALE: 1/2" = 1'-0"


I
A-4

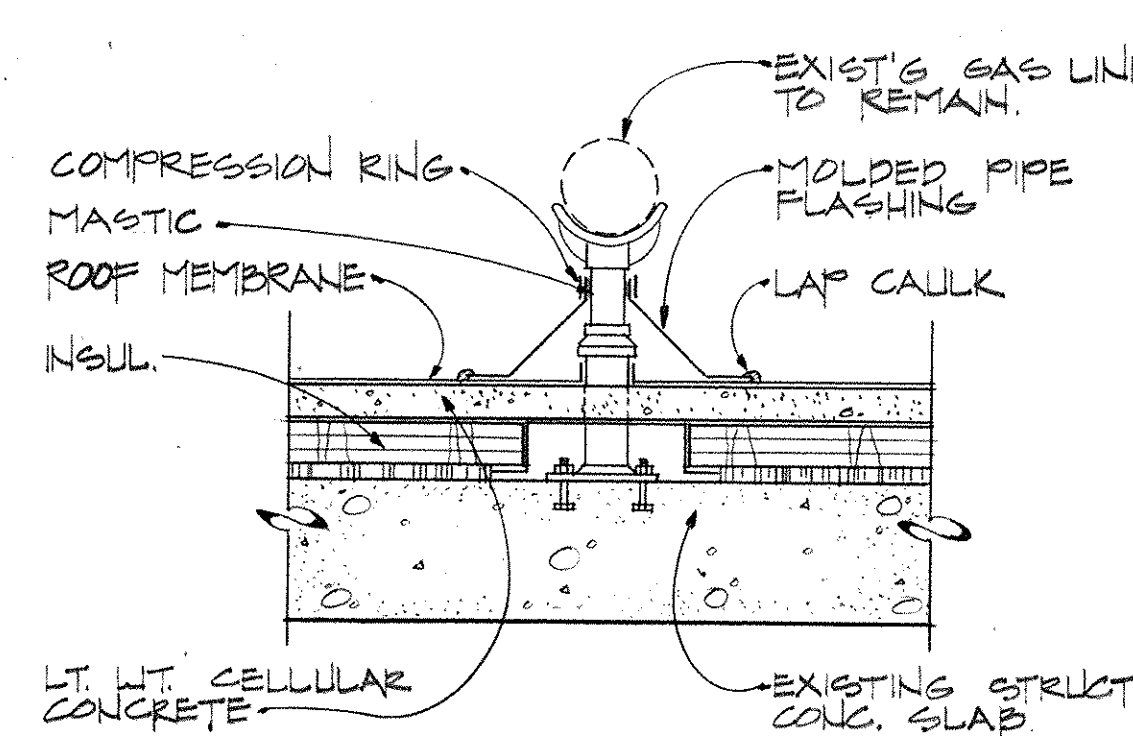

GAS PIPING DETAIL

1/2" SCALE

J
A-4

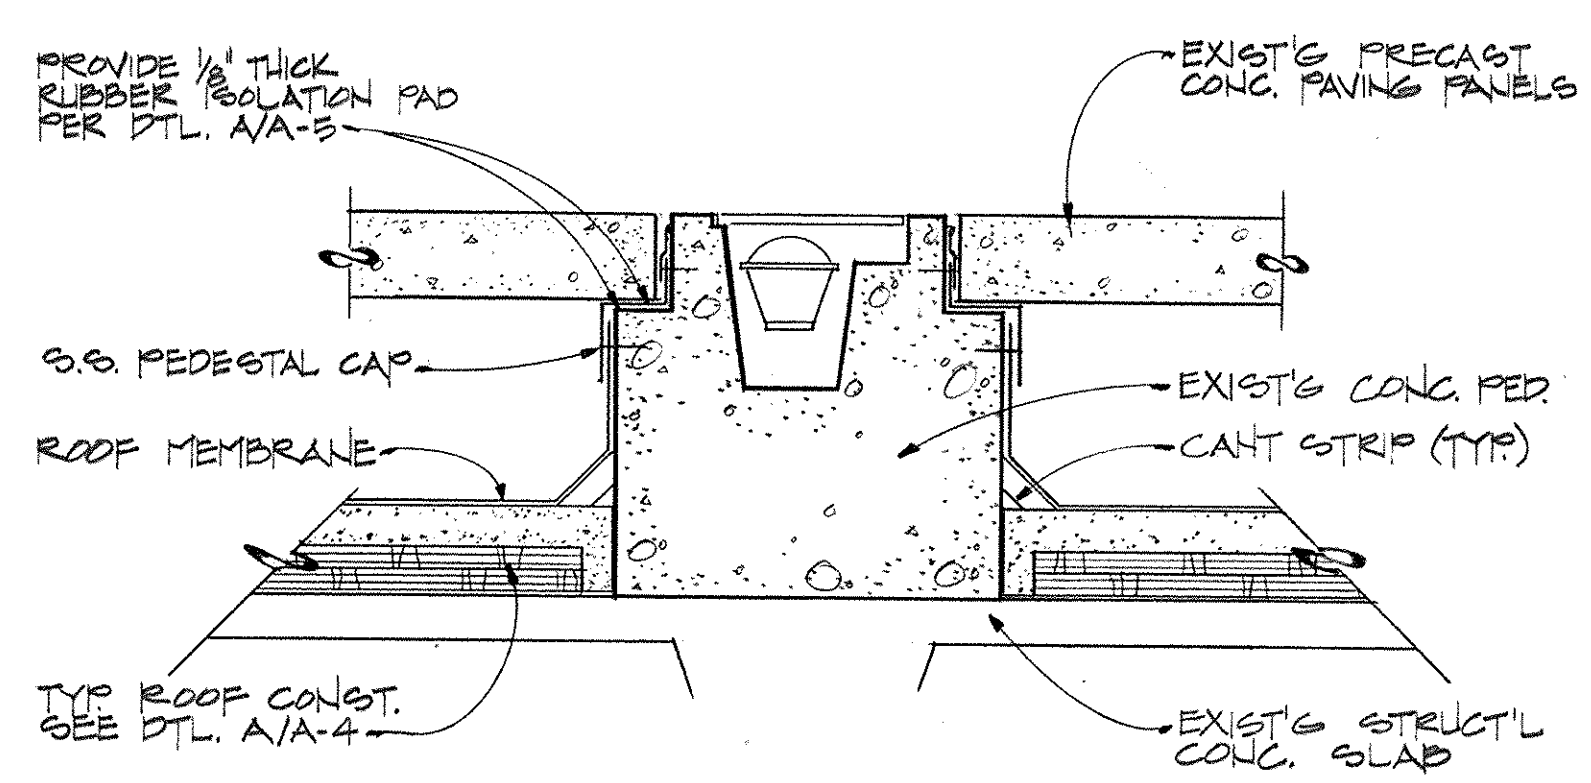


TYPE 'PE' LIGHT FIXTURE DETAIL

SCALE: 1" = 1'-0"

K
A-4

NO.	REVISIONS	DATE
1		
2		
3		
4		
5		
6		
7		
8		
9		

CAPITAL PLAZA ROOF REPAIR FRANKFORT, KENTUCKY		
DETAILS		
AS BUILT DATE...	DRAWING NO. A-4	
DRAWN BY FKJ	COMMONWEALTH OF KENTUCKY FINANCE AND ADMINISTRATION CABINET DEPARTMENT FOR FACILITIES MANAGEMENT DIVISION OF ENGINEERING FRANKFORT, KENTUCKY	
CHECKED BY JAR	ROSS • FELDMAN ARCHITECTURE, INC.	
A & E FILE NO. 9016.1	206 West Main Street, Lexington, Kentucky 40507 606.254-4008	
DATE APRIL 1992	ENGR. FILE NO. M-219-35-B	
AGENCY AUTHORIZED AGENT James A. Ross	APPROVED FOR PROGRAM CONCEPT ONLY DATE 5-12-92	
DIVISION OF ENGINEERING	APPROVED FOR PROGRAM CONCEPT ONLY DATE 5-12-92	






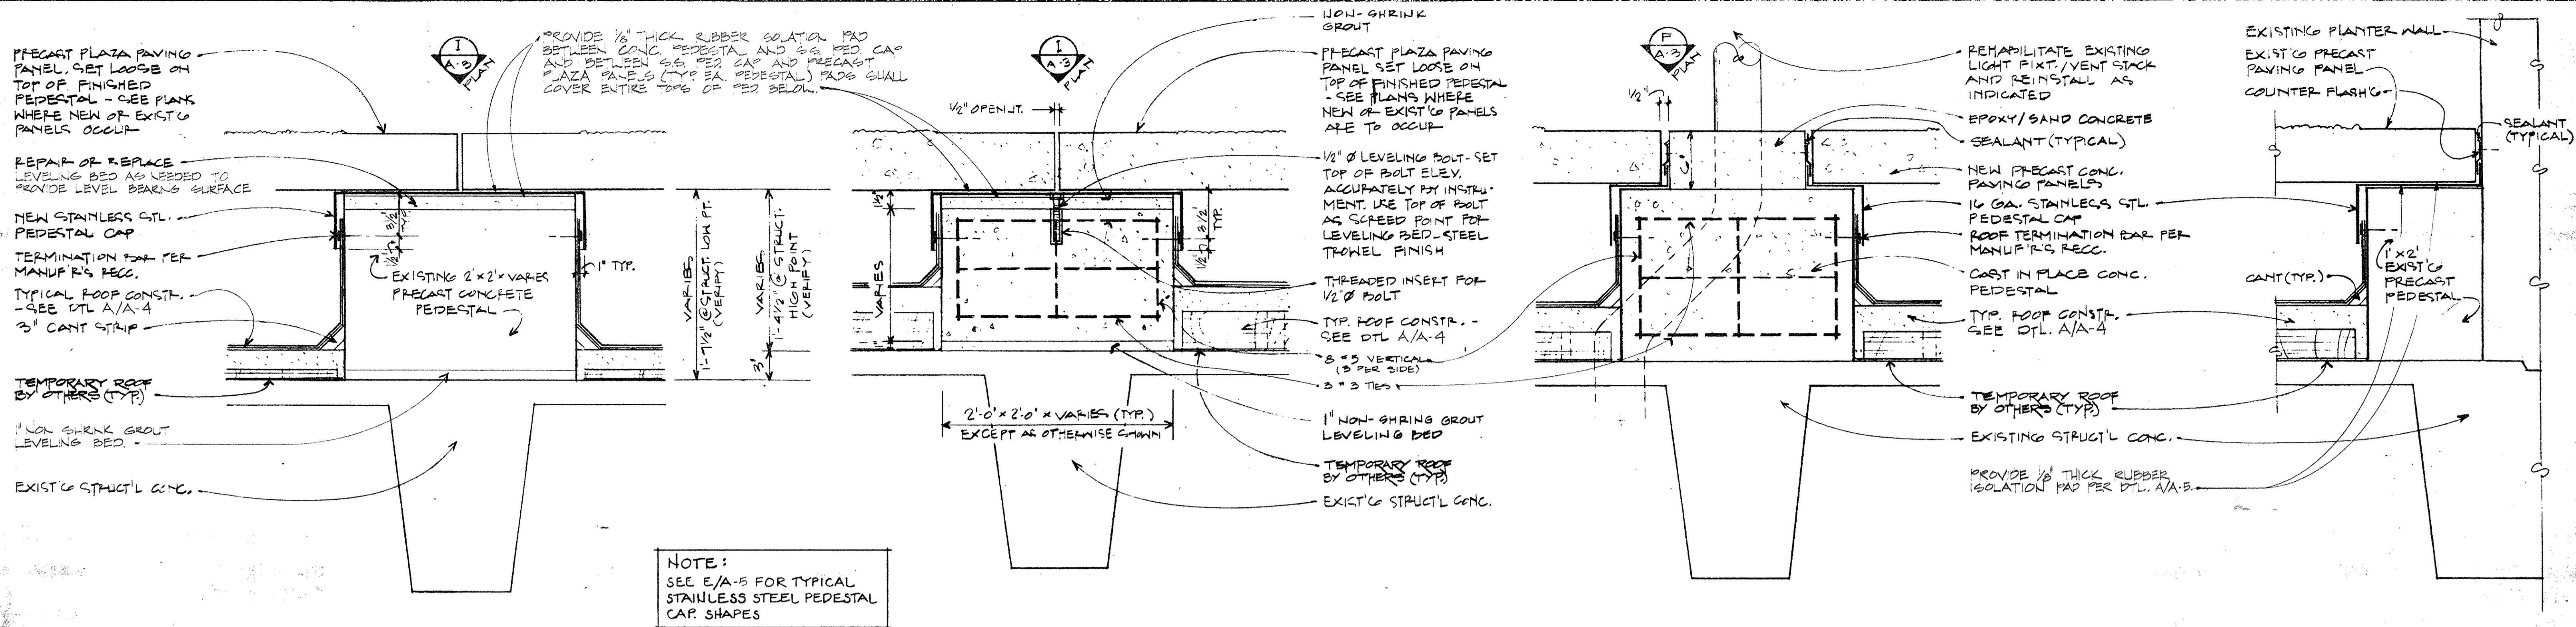


EXISTING PRECAST PEDESTAL DETAIL (TYP.)
SCALE: 1/2" = 1'-0"

NEW PRECAST PEDESTAL DETAIL (TYP.)
SCALE: 1/2" = 1'-0"

PEDESTAL @ LIGHT FIXT./VENT STACK
SCALE: 1/2" = 1'-0"

TYPICAL PEDESTAL @ PLANTER WALL
SCALE: 1/2" = 1'-0"

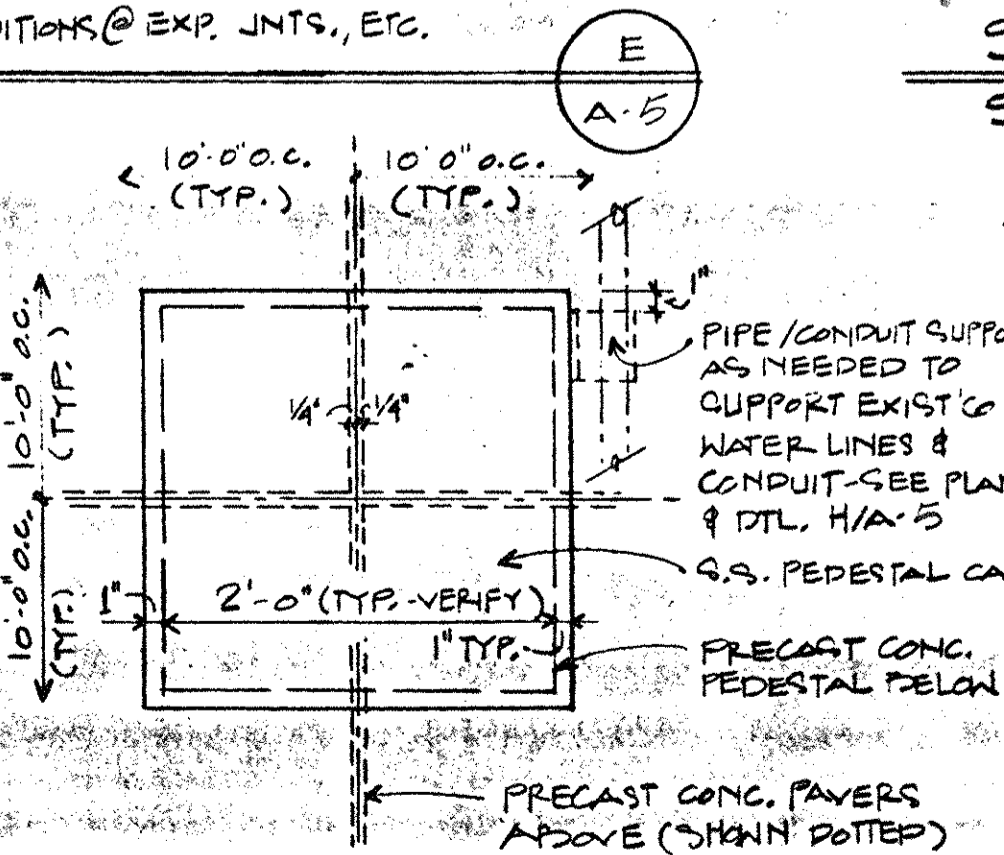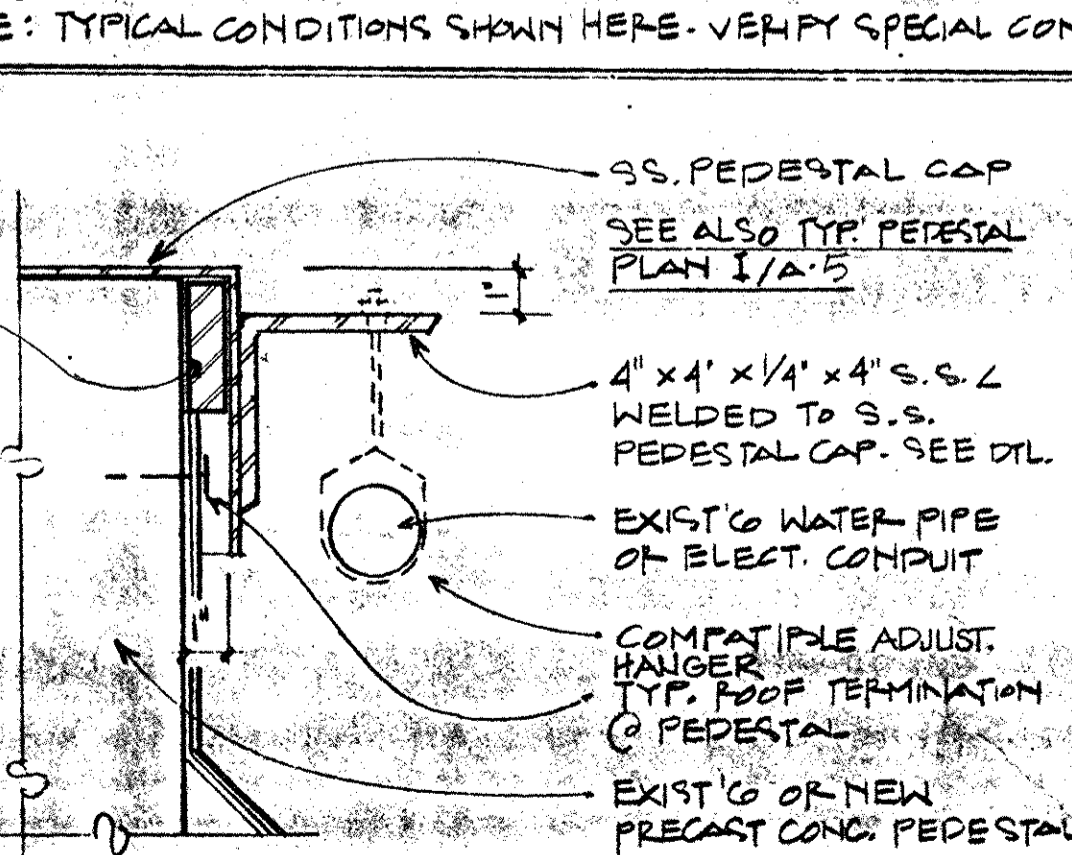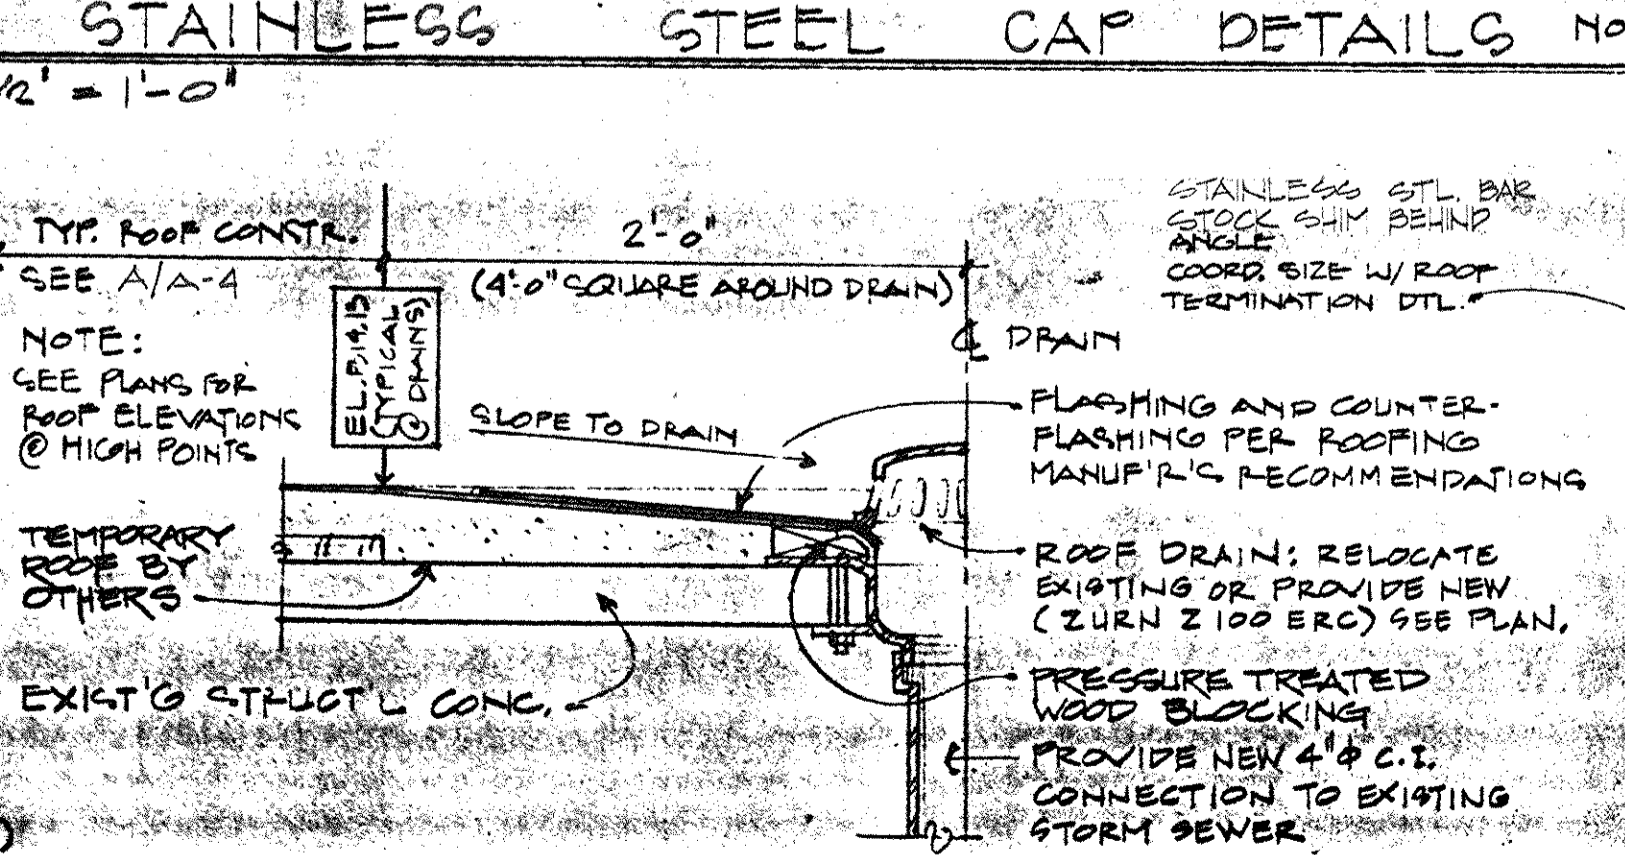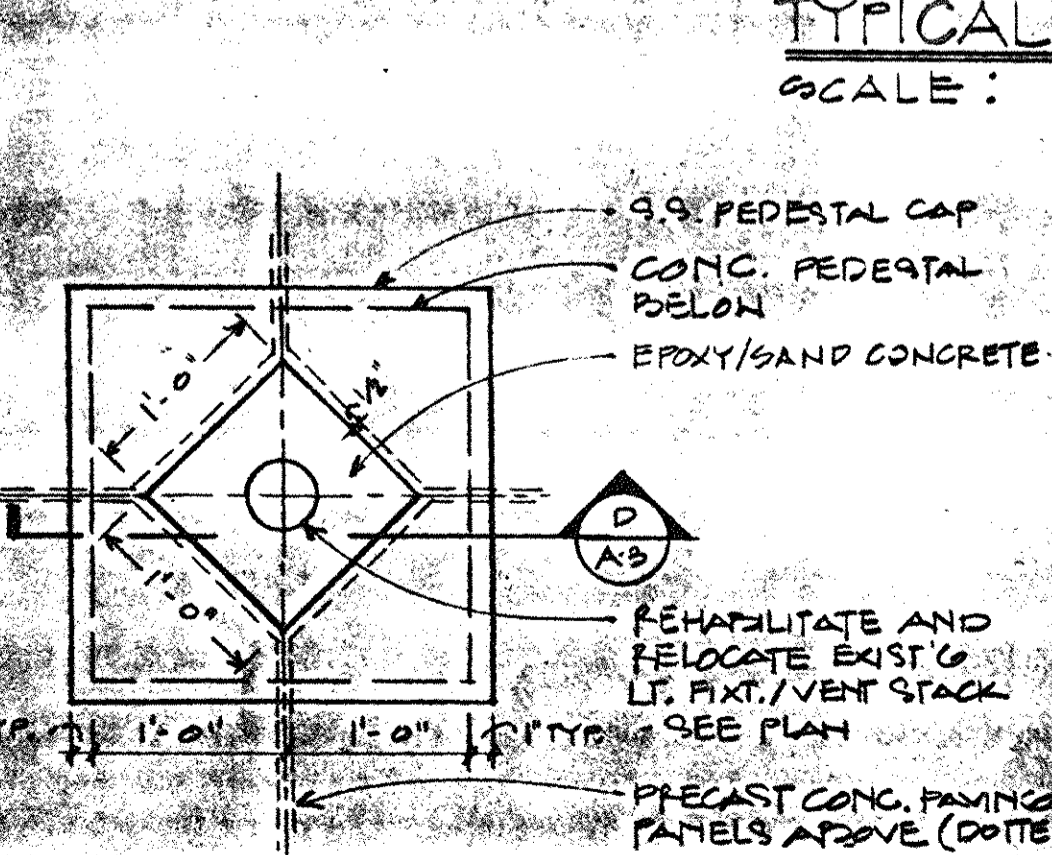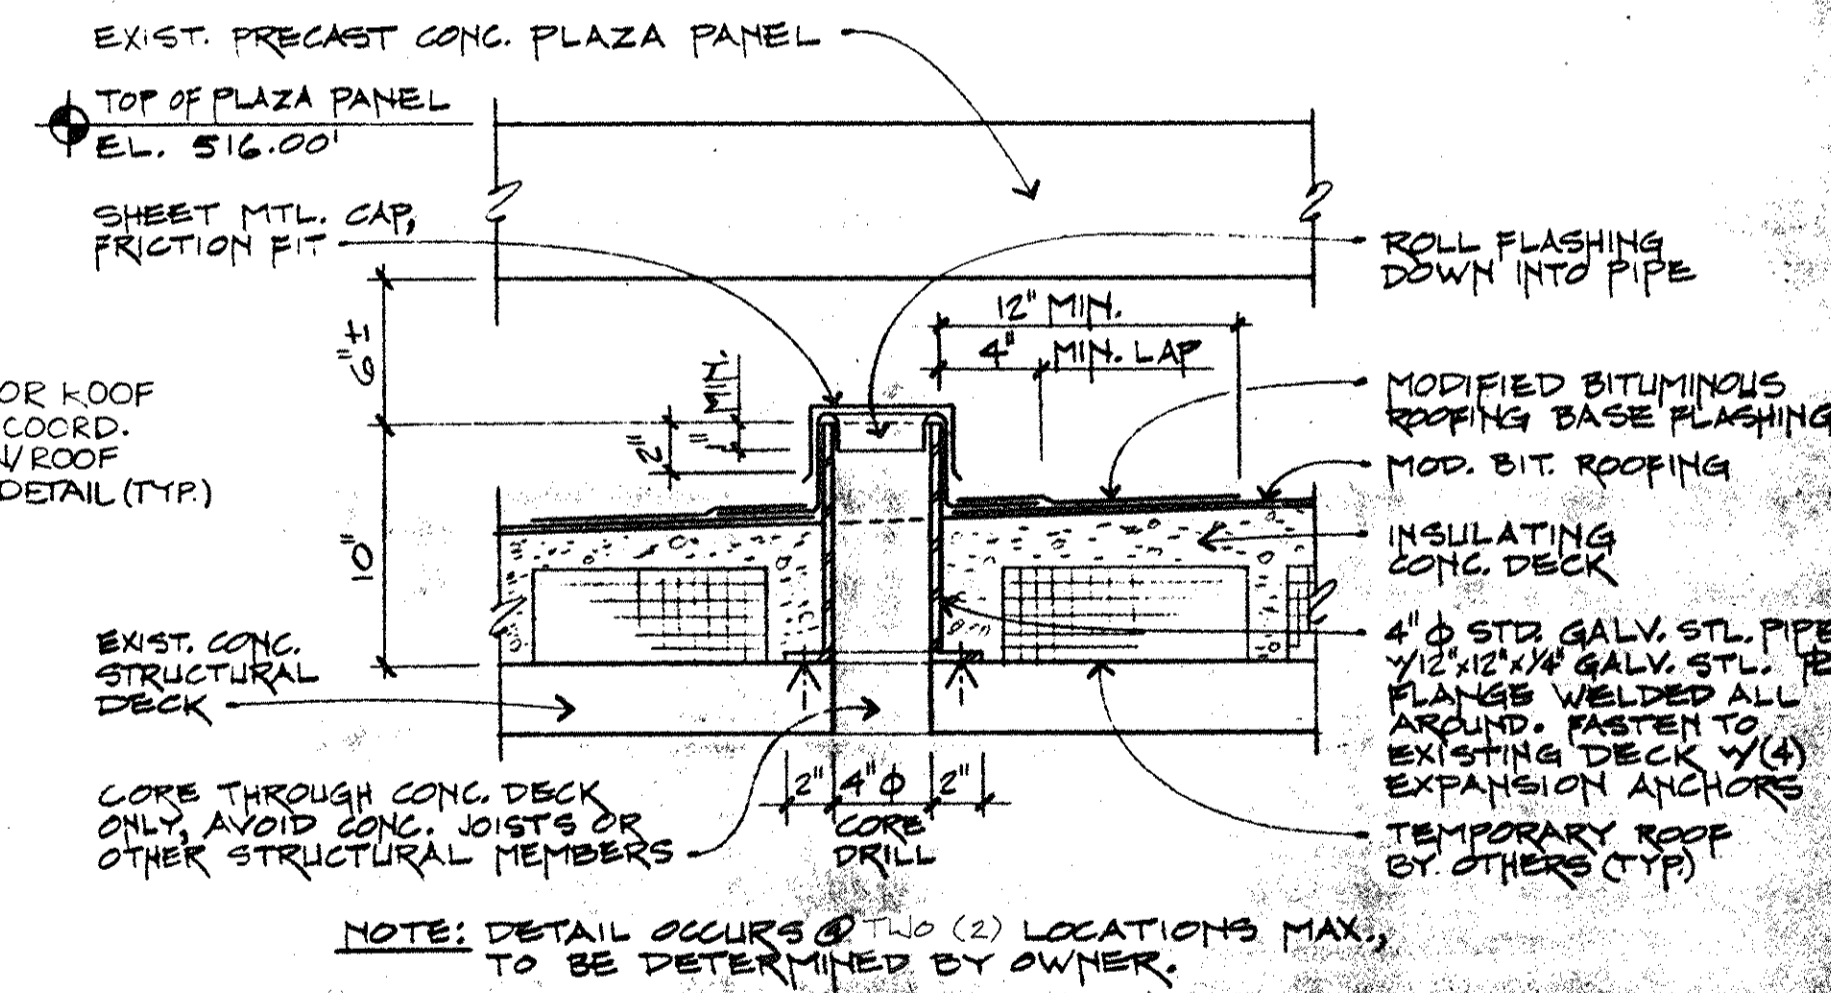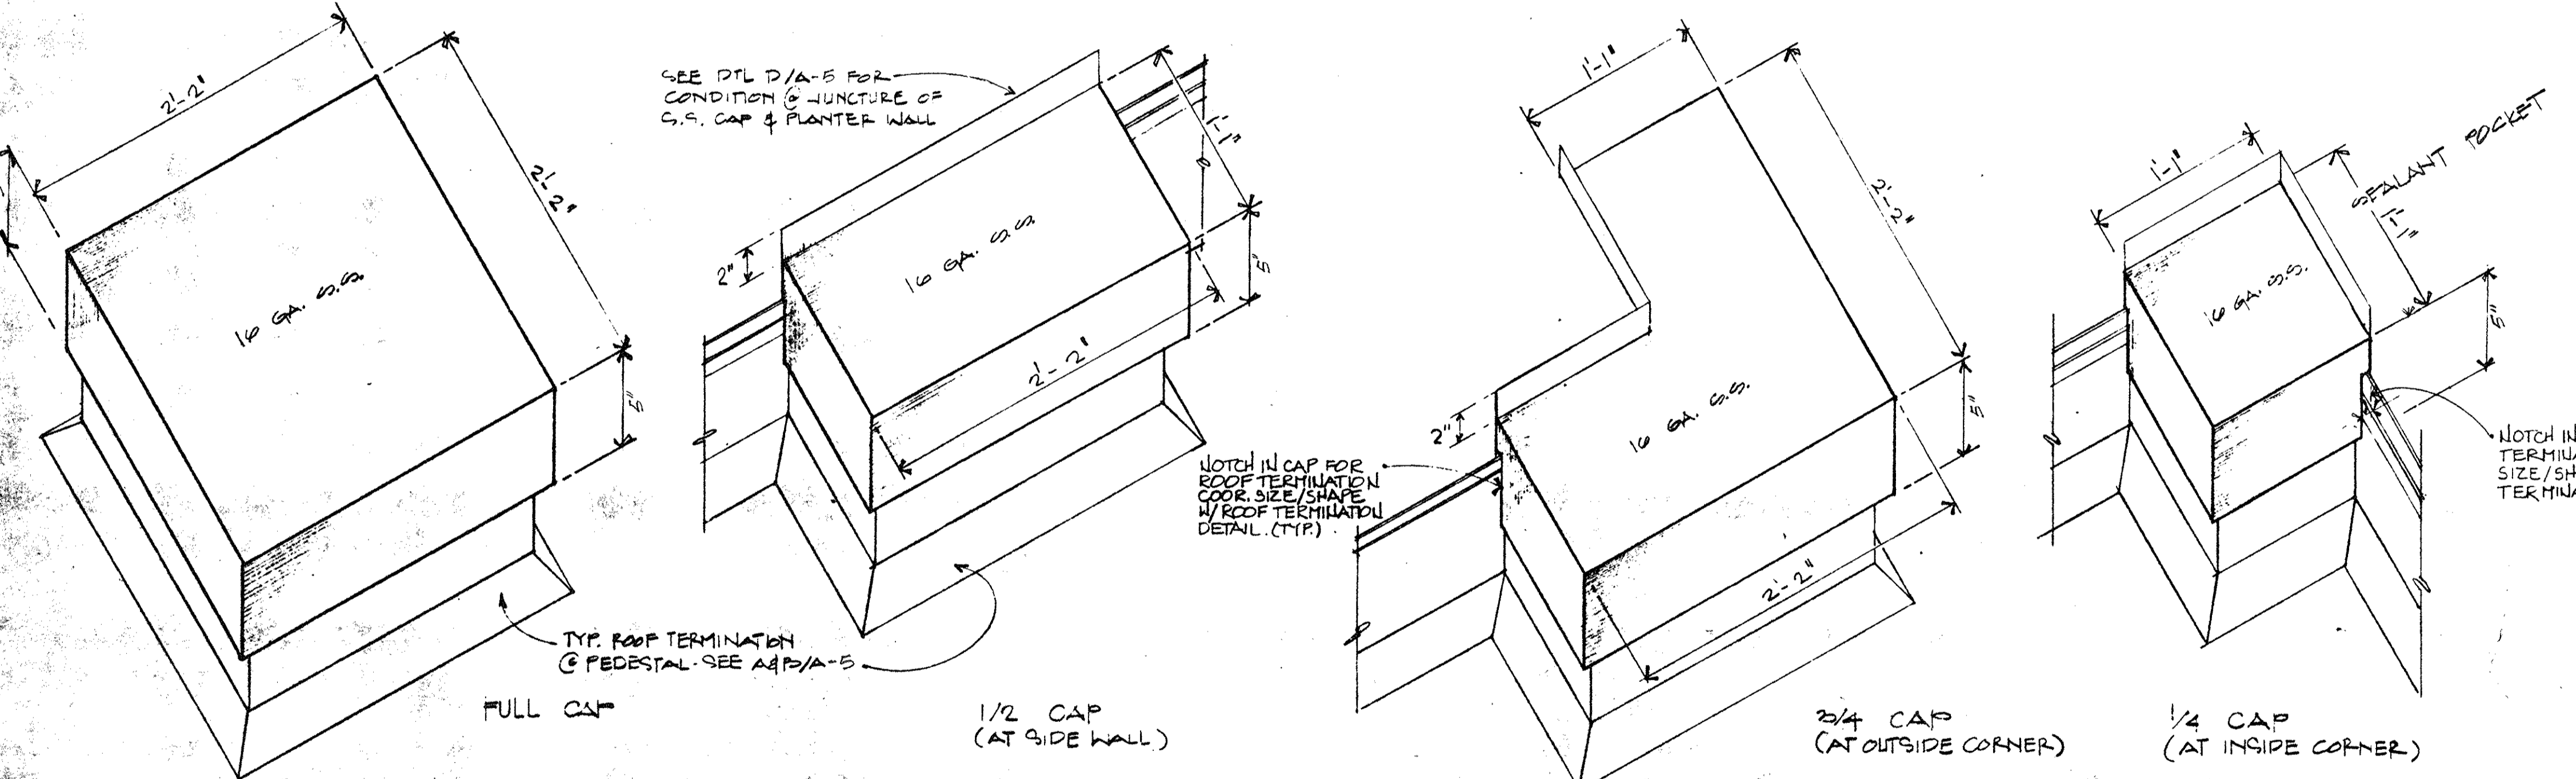

REVISIONS		DATE	Capital Plaza Roof Replacement	
1			RECORD DRAWING DATE	DRAWING NO. A-5
2				
3				
4				
5				
6				
7				
8				
9				

DETAILS

COMMONWEALTH OF KENTUCKY
FINANCE AND ADMINISTRATION CABINET
DEPARTMENT FOR FACILITIES MANAGEMENT
DIVISION OF ENGINEERING
FRANKFORT, KENTUCKY

ROSS FELDMAN ARCHITECTURE, INC.

1320
206 West Main Street, Lexington, Kentucky 40507 606 254-4016

APRIL 1992

AGENCY AUTHORIZED AGENT
APPROVED FOR PROGRAM CONCEPT ONLY

DIVISION OF ENGINEERING
APPROVED FOR PROGRAM CONCEPT ONLY

DATE

DATE